CONSTRUCTION DOCUMENTS

12" PUBLIC SEWER EXTENSION

PUBLIC SEWER - PHASE 3

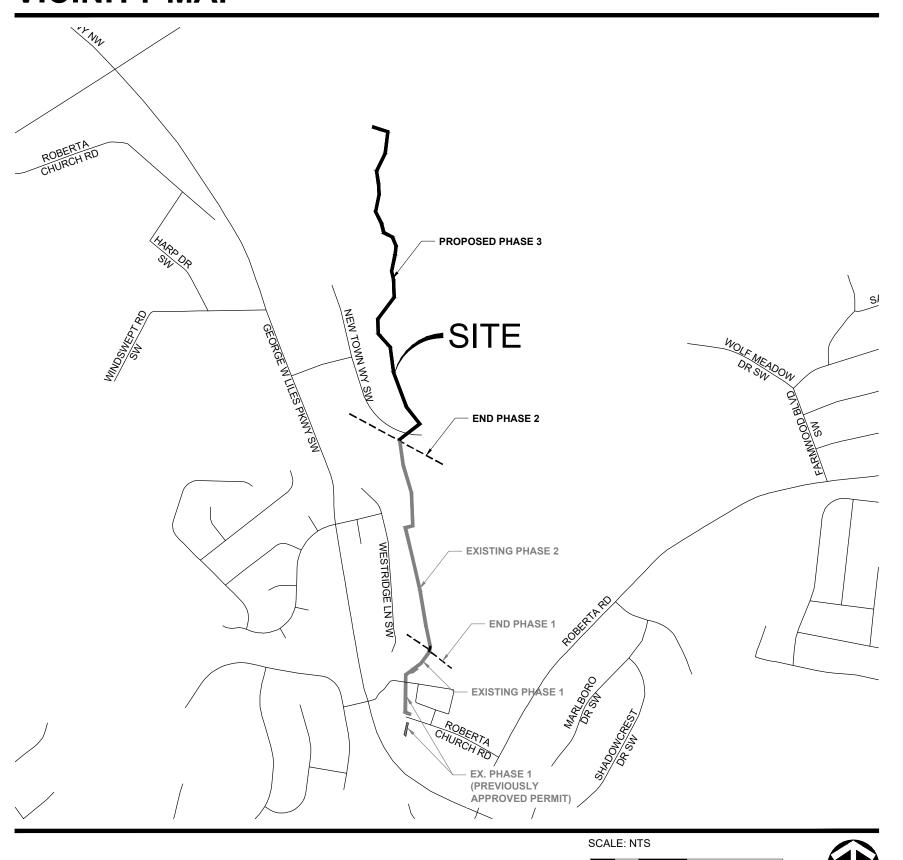
CONCORD, NC

DATE: 02.27.2024

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VICINITY MAP



PROJECT TEAM

OWNER

CITY OF CONCORD **PO BOX 308** CONCORD, NC 28026 704-920-5401 **CONTACT NAME: SUE HYDE**

CIVIL ENGINEER

LANDDESIGN 223 NORTH GRAHAM STREET CHARLOTTE, NC 28202 704.333.0325 **CONTACT NAME: ROBERT KEIDEL**

SURVEYOR

R.B. PHARR & ASSOCIATES, P.A. **420 HAWTHORNE LANE** CHARLOTTE, NC 28204 704.376.2186





1. LANDDESIGN, INC. DOES NOT INTEND FOR THE INCLUDED CONSTRUCTION SEQUENCING TO DICTATE NOR TAKE RESPONSIBILITY FOR CONSTRUCTION MEANS, METHODS, TECHNIQUES, PROCEDURES, AND SAFETY PRECAUTIONS WHICH ARE GOVERNED BY LOCAL, STATE AND FEDERAL GUIDELINES. THE CONTRACTOR IS SOLELY RESPONSIBLE FOR ALL CONSTRUCTION RELATED ACTIVITIES ASSOCIATED WITH THIS PROJECT.

CONSTRUCTION SEQUENCE

- 1. CONTRACTOR SHALL ENSURE THAT ALL NECESSARY PERMITS HAVE BEEN RECIEVED AND THAT
- THOSE REQUIRED TO BE DISPLAYED ON-SITE ARE AVAILABLE. 2. CONTRACTOR SHALL HOLD ON-SITE PRE-CONSTRUCTION MEETING A MINIMUM OF 48 HOURS
- PRIOR TO CONSTRUCTION. 3. CONTRACTOR SHALL CONTACT CAROLINA ONE CALL AND ALL ENTITIES HAVING BURIED UTILITIES AT LEAST 72 HOURS PRIOR TO DIGGING OR AS DIRECTED AT THE PRE-CONSTRUCTION
- 4. CONTRACTOR SHALL INSTALL TEMPORARY CONSTRUCTION ENTRANCES (IF ANY) AT EACH POINT OF ACCESS STORAGE AND CONSTRUCTION AREAS.
- 5. SEDIMENT AND EROSION CONTROL MEASURES SHALL BE INSTALLED IN ACCORDANCE WITH PLANS AND BEFORE START OF WORK THE CONTRACTOR SHALL NOT INSTALL FROSION CONTROL MEASURES WHERE THE WORK WILL NOT OCCUR FOR SOME TIME. ADDITIONAL EROSION CONTROL MEASURES MAY BE REQUIRED BY CITY/ PROJECT ENGINEER OR UPON NCDEQ. DWR. AND/OR DEMLR PERSONNEL AS CONDITIONS WARRANT.
- 6. STABILIZATION FOR THIS PROJECT SHALL COMPLY WITH THE TIME FRAME GUIDELINES AS SPECIFIED BY THE NCG-01000 GENERAL CONSTRUCTION PERMIT ISSUED BY THE NORTH CAROLINA DEPARTMENT OF ENVIRONMENTAL QUALITY, DIVISION OF WATER RESOURCES, AND DIVISION OF ENERGY, MINERAL, AND LAND RESOURCES-EROSION AND SEDIMENTATION CONTROL SECTION.

- 7. ALL SECTIONS SHALL BE SEEDED AT EARLIEST POSSIBLE DATE AFTER INSTALLATION OF PIPE, 9.
- ONCE GROUND COVER IS FIRMLY ESTABLISHED, ALL TEMPORARY EROSION CONTROL MEASURES SHALL BE REMOVED WITH THE APPROVAL OF CITY/ NCDEQ / DWR INSPECTOR. 9. CONTRACTOR SHALL COORDINATE CONSTRUCTION ACTIVITY WITH THE CITY ENGINEERING

- 1. BASE INFORMATION, INCLUDING EXISTING CONDITIONS, TOPOGRAPHY, EXISTING UTILITIES, AND BOUNDARY INFORMATION IS FROM PLANS BY: RB PHARR AND ASSOCIATES, PA. ARCHITECTURAL INFORMATION IS FROM PLANS BY: N/A WRITTEN DIMENSIONS PREVAIL OVER SCALED DIMENSIONS. NOTIFY LANDDESIGN OF ANY
- DISCREPANCIES. DIMENSIONS ARE TO FACE OF OBJECT. UNLESS NOTED OTHERWISE. THE CONTRACTOR IS RESPONSIBLE FOR VERIFYING ALL UNDERGROUND UTILITIES. PIPES.

AND EXISTING UTILITIES ARE TO BE REPAIRED IMMEDIATELY AT NO ADDITIONAL EXPENSE TO

- THE OWNER. LANDDESIGN ASSUMES NO RESPONSIBILITY FOR ANY UTILITIES NOT SHOWN ON ALL PROPOSED FINISHED GRADES ARE BASED ON INFORMATION PROVIDED BY THE OWNER'S SURVEY AND OR CIVIL ENGINEER. ANY DISCREPANCIES IN ACTUAL FIELD MEASUREMENTS ARE
- TO BE REPORTED TO LANDDESIGN IMMEDIATELY. CONTRACTOR IS RESPONSIBLE TO PROVIDE AND INSTALL ALL ITEMS PER DRAWINGS AND SPECIFICATION. NOTIFY LANDDESIGN OF ANY MAJOR DISCREPANCIES BETWEEN CONTRACTOR'S VERIFIED QUANTITIES, BID BOOK, AND INTENT OF DRAWING. CONTRACTOR IS RESPONSIBLE FOR ALL FINAL QUANTITIES PER DRAWINGS AND
- SPECIFICATIONS ANY QUANTITIES PROVIDE BY LANDDESIGN ARE PROVIDED FOR CONVENIENCE ONLY AND SHALL NOT BE CONSIDERED ABSOLUTE. LANDDESIGN SHOULD BE NOTIFIED OF ANY

THE CONTRACTOR SHALL EXAMINE AND BECOME FAMILIAR WITH ALL CONTRACT DOCUMENTS IN LAYOUT NOTES:

- THEIR ENTIRETY. SURVEY THE PROJECT AND BECOME FAMILIAR WITH THE EXISTING CONDITIONS AND SCOPE OF WORK. ALL COSTS SUBMITTED SHALL BE BASED ON THOROUGH KNOWLEDGE OF ALL WORK AND MATERIALS REQUIRED ANY DISCREPANCY AND/ OR UNCERTAINTY AS TO WHAT MATERIAL OR PRODUCT IS TO BE USED, SHALL BE VERIFIED WITH THE OWNER OR LANDDESIGN PRIOR TO BIDDING.
- 10. THE CONTRACTOR SHALL BE SOLELY RESPONSIBLE FOR CONSTRUCTION MEANS, METHODS, TECHNIQUES, SEQUENCES AND PROCEDURES REQUIRED FOR SAFE EXECUTION AND COMPLETION OF WORK, AND FOR INITIATING, MAINTAINING AND SUPERVISING ALL SAFETY PRECAUTIONS AND PROGRAMS IN CONNECTION WITH THE WORK. 11. IN THE EVENT A DISCREPANCY IS FOUND IN THE CONTRACT DOCUMENTS, THE OWNER &
- LANDDESIGN SHALL BE NOTIFIED IMMEDIATELY. 12. CONTRACTOR SHALL VERIFY ALL DIMENSIONS IN THE FIELD AND NOTIFY LANDDESIGN OF ANY DISCREPANCIES PRIOR TO CONSTRUCTION.
- 13. CONTRACTOR SHALL VERIFY ALL MEASUREMENTS AT THIS SITE AND AND BE RESPONSIBLE FOR ACCURACY AND CORRECTNESS OF SAME. STRUCTURES, AND LINE RUNS IN THE FIELD PRIOR TO CONSTRUCTION. ANY DAMAGE TO NEW 14. CONTRACTOR SHALL COORDINATE WORK WITH ALL OTHER TRADES AND NOTIFY OWNER & LANDDESIGN OF ANY DISCREPANCIES PRIOR TO CONSTRUCTION.
 - ALL EXISTING WORK OR LANDSCAPING NOT SHOWN TO BE ALTERED OR REMOVED SHALL BE PROTECTED FROM DAMAGE DURING CONSTRUCTION. THE CONTRACTOR(S) SHALL BEAR THE TOTAL EXPENSE FOR AND SHALL REPAIR ANY DAMAGE TO EXISTING CONDITIONS OR IMPROVEMENTS NOT INDICATED IN THE DRAWINGS OR SPECIFICATIONS TO RECEIVE ALTERATION. ADDITIONS OR REMOVAL.

- 1. ALL MATERIALS AND CONSTRUCTION WITHIN RIGHT OF WAYS SHALL BE IN ACCORDANCE WITH NCDOT AND CITY OF CONCORD STANDARDS AND SPECIFICATIONS AND ALL OTHER CITY, STATE AND FEDERAL REGULATIONS AND/OR STANDARDS.
- EXISTING UTILITIES ARE SHOWN SCHEMATICALLY AND ARE FOR THE CONTRACTOR'S GUIDANCE ONLY. THE LOCATION AND/OR ELEVATION OF EXISTING UTILITIES AS SHOWN ON THESE PLANS ARE BASED ON RECORDS OF THE VARIOUS UTILITY COMPANIES. AND. WHERE POSSIBLE. MEASUREMENTS TAKEN IN THE FIELD. THE CONTRACTOR MUST CALL THE APPROPRIATE UTILITY COMPANY AT LEAST 48 HOURS PRIOR TO ANY EXCAVATION TO REQUEST EXACT FIELD
- CONTRACTOR SHALL BE RESPONSIBLE FOR PROTECTING ALL EXISTING IMPROVEMENTS IN THE CONSTRUCTION OF THIS PROJECT. THE CONTRACTOR IS RESPONSIBLE FOR REPAIRS OF DAMAGE TO ANY EXISTING IMPROVEMENTS DURING CONSTRUCTION. REPAIRS SHALL BE EQUAL TO OR BETTER THAN CONDITION PRIOR TO CONSTRUCTION.
- . BOUNDARY SURVEY: BOUNDARY SURVEY INFORMATION IS BASED ON THE BOUNDARY SURVEY PREPARED BY RB PHARR AND ASSOCIATES, PA. REFER TO THE BOUNDARY SURVEY AND PLAT TO VERIFY PROPERTY LINES AND EASEMENT LOCATIONS.

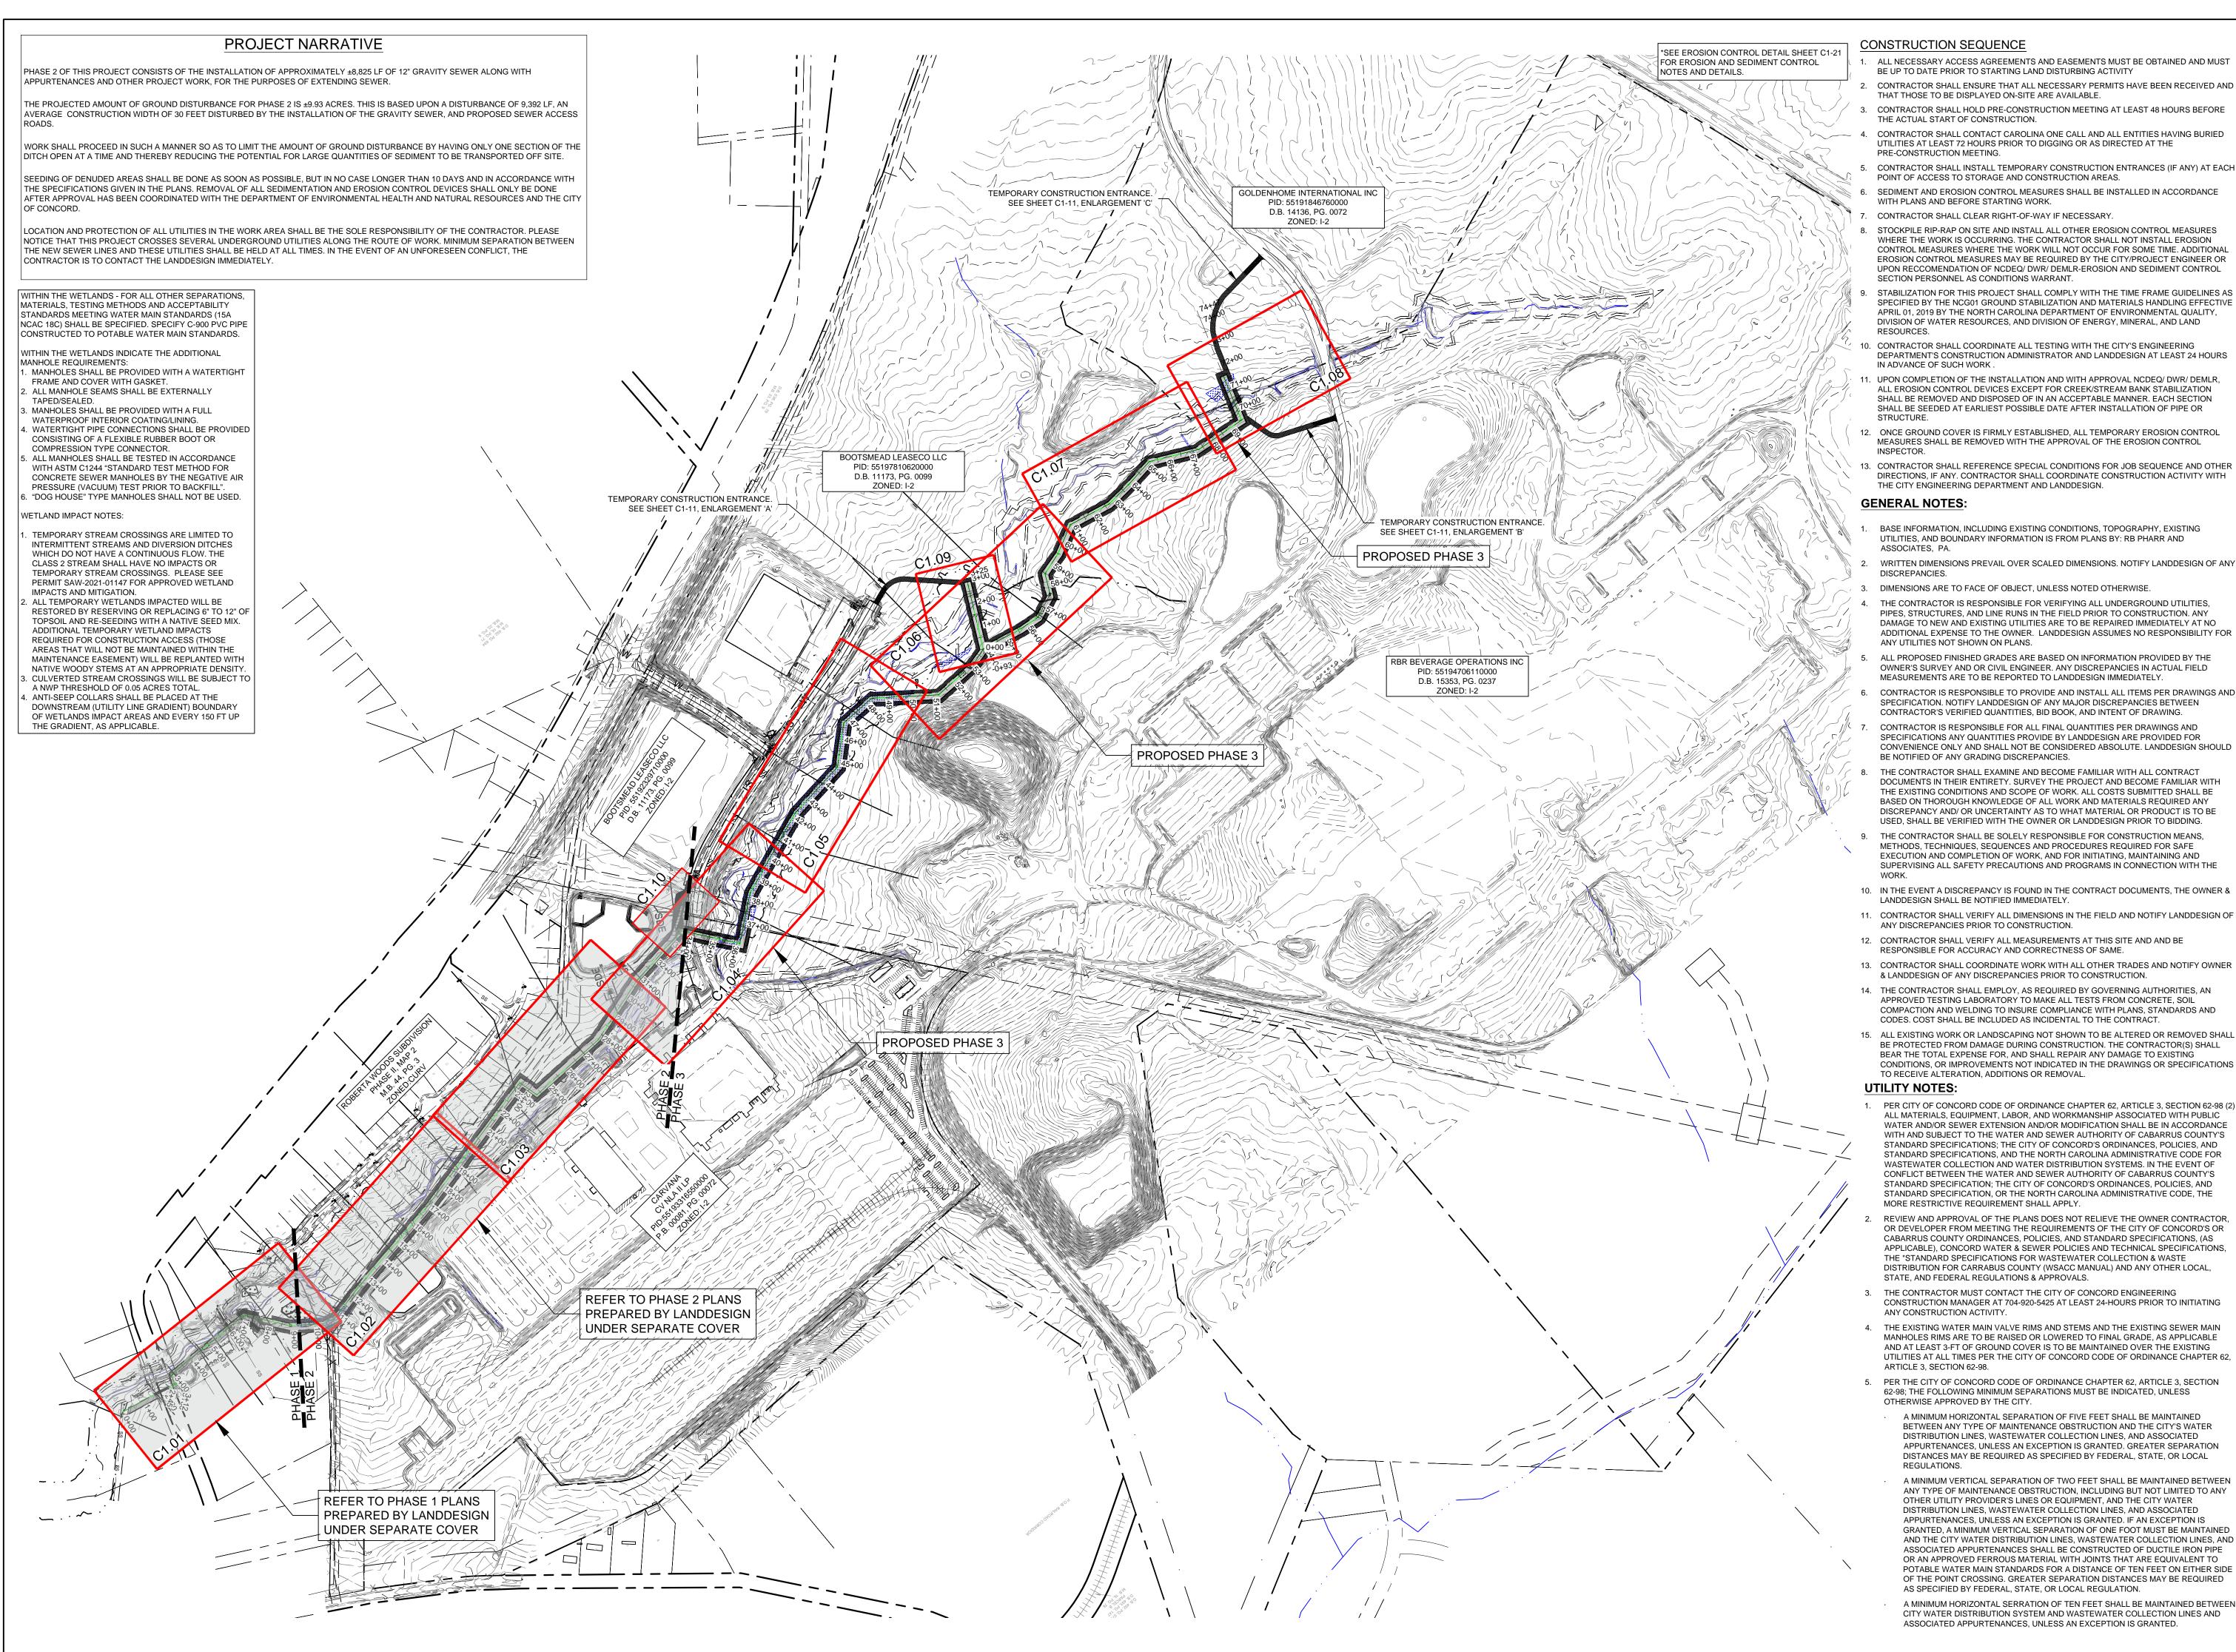
- Concord Notes

 1. PER CITY OF CONCORD CODE OF ORDINANCE CHAPTER 62, ARTICLE 3, SECTION 62-98 (2) ALL MATERIALS, EQUIPMENT, LABOR, AND WORKMANSHIP ASSOCIATED WITH PUBLIC WATER AND / OR SEWER EXTENSION AND/OR MODIFICATION SHALL BE IN ACCORDANCE WITH AND SUBJECT TO THE WATER AND SEWER AUTHORITY OF CABARRUS COUNTY'S STANDARD SPECIFICATIONS; THE CITY OF CONCORD'S ORDINANCES, POLICIES, AND STANDARD SPECIFICATIONS, AND THE NORTH CAROLINA ADMINISTRATIVE CODE FOR WASTEWATER DISTRIBUTION SYSTEMS. IN THE EVENT OF CONFLICT BETWEEN THE WATER AND SEWER AUTHORITY OF CABARRUS COUNTY'S STANDARD SPECIFICATIONS; THE CITY OF CONCORD'S ORDINANCES, POLICIES, AND STANDARD SPECIFICATIONS, OR THE NORTH CAROLINA CODE, THE
- MOST RESTRICTIVE REQUIREMENTS SHALL APPLY REVIEW AND APPROVAL OF THE PLANS DOES RELIEVE THE OWNER, CONTRACTOR, OR DEVELOPER FROM MEETING THE REQUIREMENTS OF THE CITY OF CONCORD'S OR CABARRUS COUNTY ORDINANCES, POLICIES, AND STANDARD SPECIFICATIONS, (AS APPLICABLE), CONCORD WATER & SEWER POLICIES AND TECHNICAL SPECIFICATIONS, THE "STANDARD SPECIFICATION FOR WASTEWATER COLLECTION & WASTE DISTRIBUTION FOR CABARRUS COUNTY (WSACC MANUAL) AND ANY OTHER LOCAL, STATE, AND FEDERAL REGULATIONS& APPROVALS. THE CONTRACTOR MUST CONTACT THE CITY OF CONCORD ENGINEERING CONSTRUCTION MANAGER AT 704-920-5425 AT LEAST 24-HOURS

INDICATED, UNLESS OTHERWISE APPROVED BY THE CITY OF CONCORD.

- PRIOR TO INITIATING ANY CONSTRUCTION ACTIVITY. THE EXISTING WATER MAIN VALVE RIMS AND STEMS AND THE EXISTING SEWER MAIN MANHOLE RIMS ARE TO BE RAISED OR LOWERED TO FINAL GRADE, AS APPLICABLE AND AT LEAST 3-FT OF GROUND COVER IS REQUIRED. PER THE CITY OF CONCORD CODE OF ORDINANCE CHAPTER 62, ARTICLE 3, SECTION 62-98 THE FOLLOWING MINIMUM SEPARATIONS MUST BE
- A MINIMUM HORIZONTAL SEPARATION OF FIVE FEET SHALL BE MAINTAINED BETWEEN ANY TYPE OF MAINTENANCE OBSTRUCTION AND THE CITY'S WATER DISTRIBUTION LINES, WASTEWATER COLLECTION LINES, AND ASSOCIATED APPURTENANCES, UNLESS AN EXCEPTION IS GRANTED. GREATER SEPERATION DISTANCES MAY BE REQUIRED AS SPECIFIED BY FEDERAL, STATE, OR LOCAL REGULATIONS. A MINIMUM VERTICAL SEPERATION OF TWO FEET SHALL BE MAINTAINED BETWEEN ANY TYPE OF MAINTENANCE OBSTRUCTION , INCLUDING BUT NOT LIMITED TO ANY OTHER UTILITY PROVIDER'S LINES OR EQUIPMENT, AND THE CITY'S WATER DISTRIBUTION LINES, WASTEWATER COLLECTION LINES, AND ASSOCIATED APPURTENANCES, UNLESS AN EXCEPTION IS GRANTED. IF AN EXCEPTION IS GRANTED, A MINIMUM VERTICAL SEPARATION OF ONE FOOT MUST BE MAINTAINED AND THE CITY WATER DISTRIBUTION LINES, WASTEWATER COLLECTION LINES, AND ASSOCIATED APPURTENANCES SHALL BE CONSTRUCTED OF DUCTILE IRON PIPE OR AN APPROVED FERROUS MATERIAL WITH JOINTS
- THAT EQUIVALENT TO POTABLE WATER MAIN STANDARDS FOR A DISTANCE OF TEN FEET ON EITHER SIDE OF THE POINT OF CROSSING. GREATER SEPARATION DISTANCES MAY BE REQUIRED AS SPECIFIED BY FEDERAL STATE OR LOCAL REGULATIONS. A MINIMUM HORIZONTAL SEPARATION OF TEN FEET SHALL BE MAINTAINED BETWEEN THE CITY WATER DISTRIBUTION SYSTEM AND WASTEWATER COLLECTION LINES, AND ASSOCIATED APPURTENANCES, UNLESS AN EXCEPTION IS GRANTED.






| LandDes

223 NORTH GRAHAM STREET CHARLOTTE, NC 28202 704.333.0325 WWW.LANDDESIGN.COM NC ENG. FIRM LICENSE # C-0658

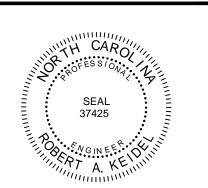KEY MAP



02.27.2023

ISSUED FOR PERMITTING

12" PUBLIC SEWER EXTENSION

PHASE 3

CITY OF CONCORD

TOF CONCORD

PO BOX 308

DESIGNED BY: LDI
DRAWN BY: RSK

CALE


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HORZ: NTS


RT: N/A RZ: NTS (NOT TO SCALE)

SEWER PLAN - OVERALL

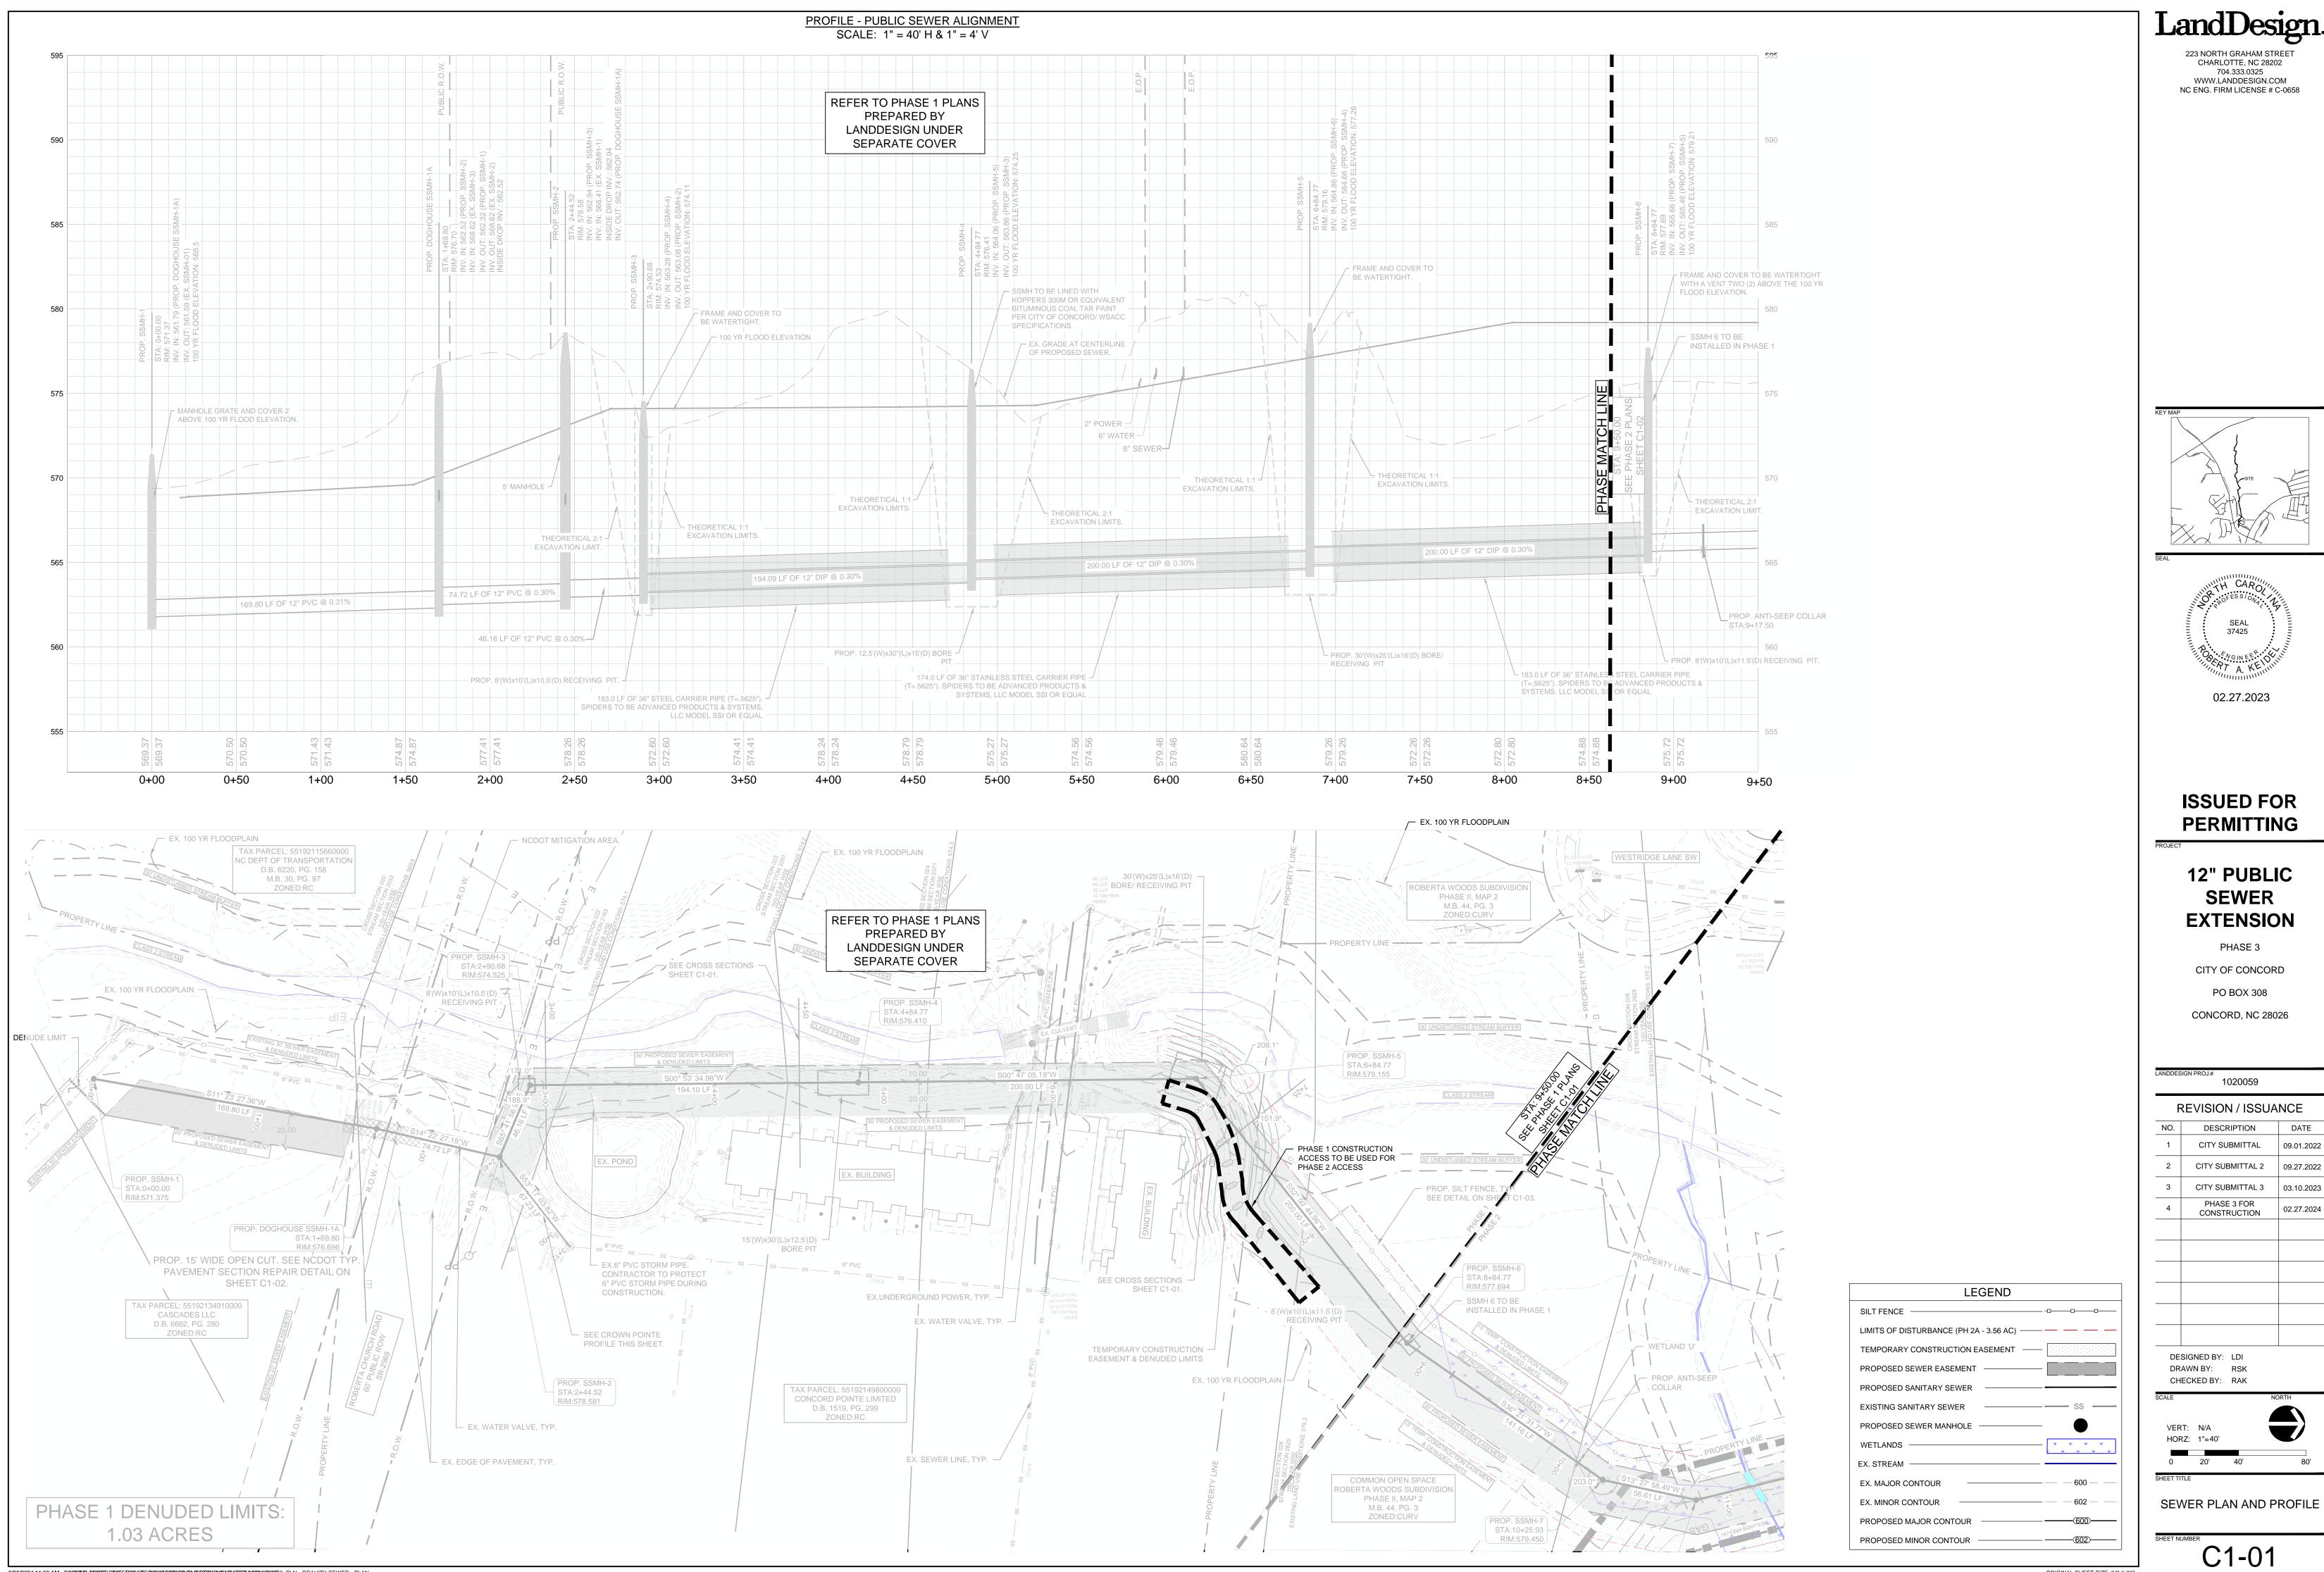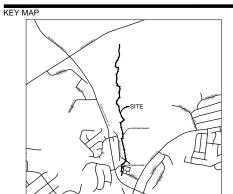BER

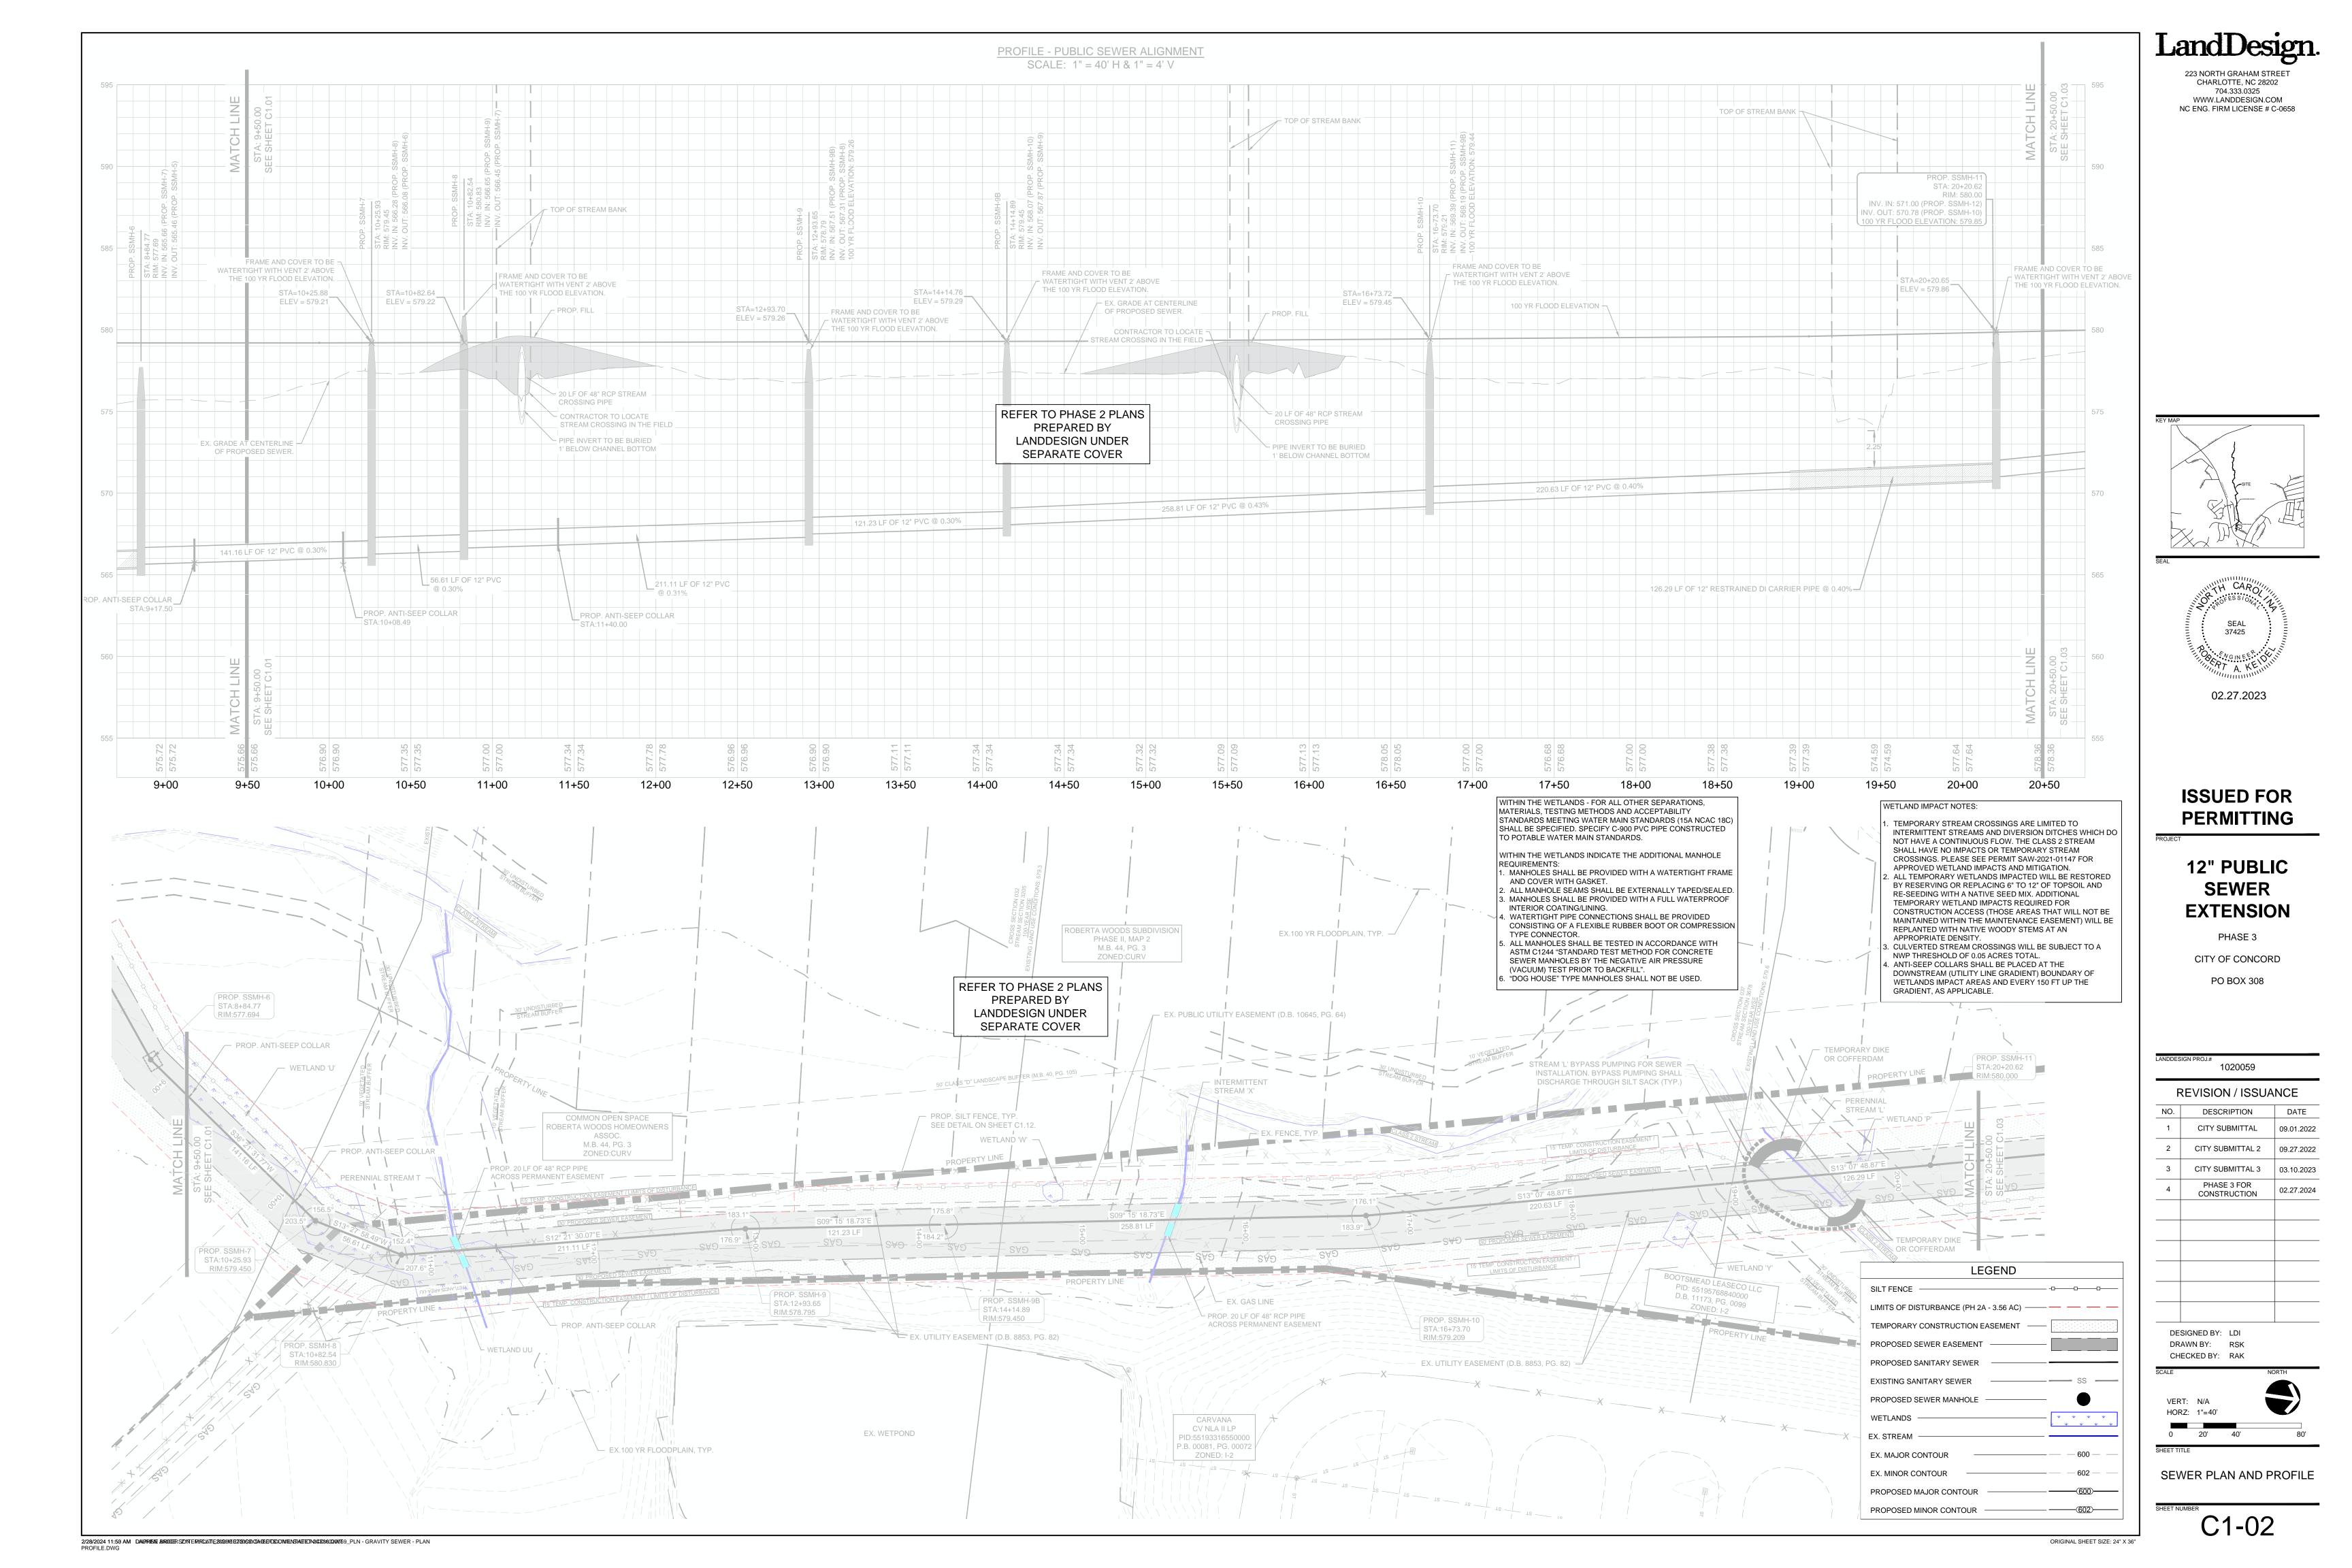
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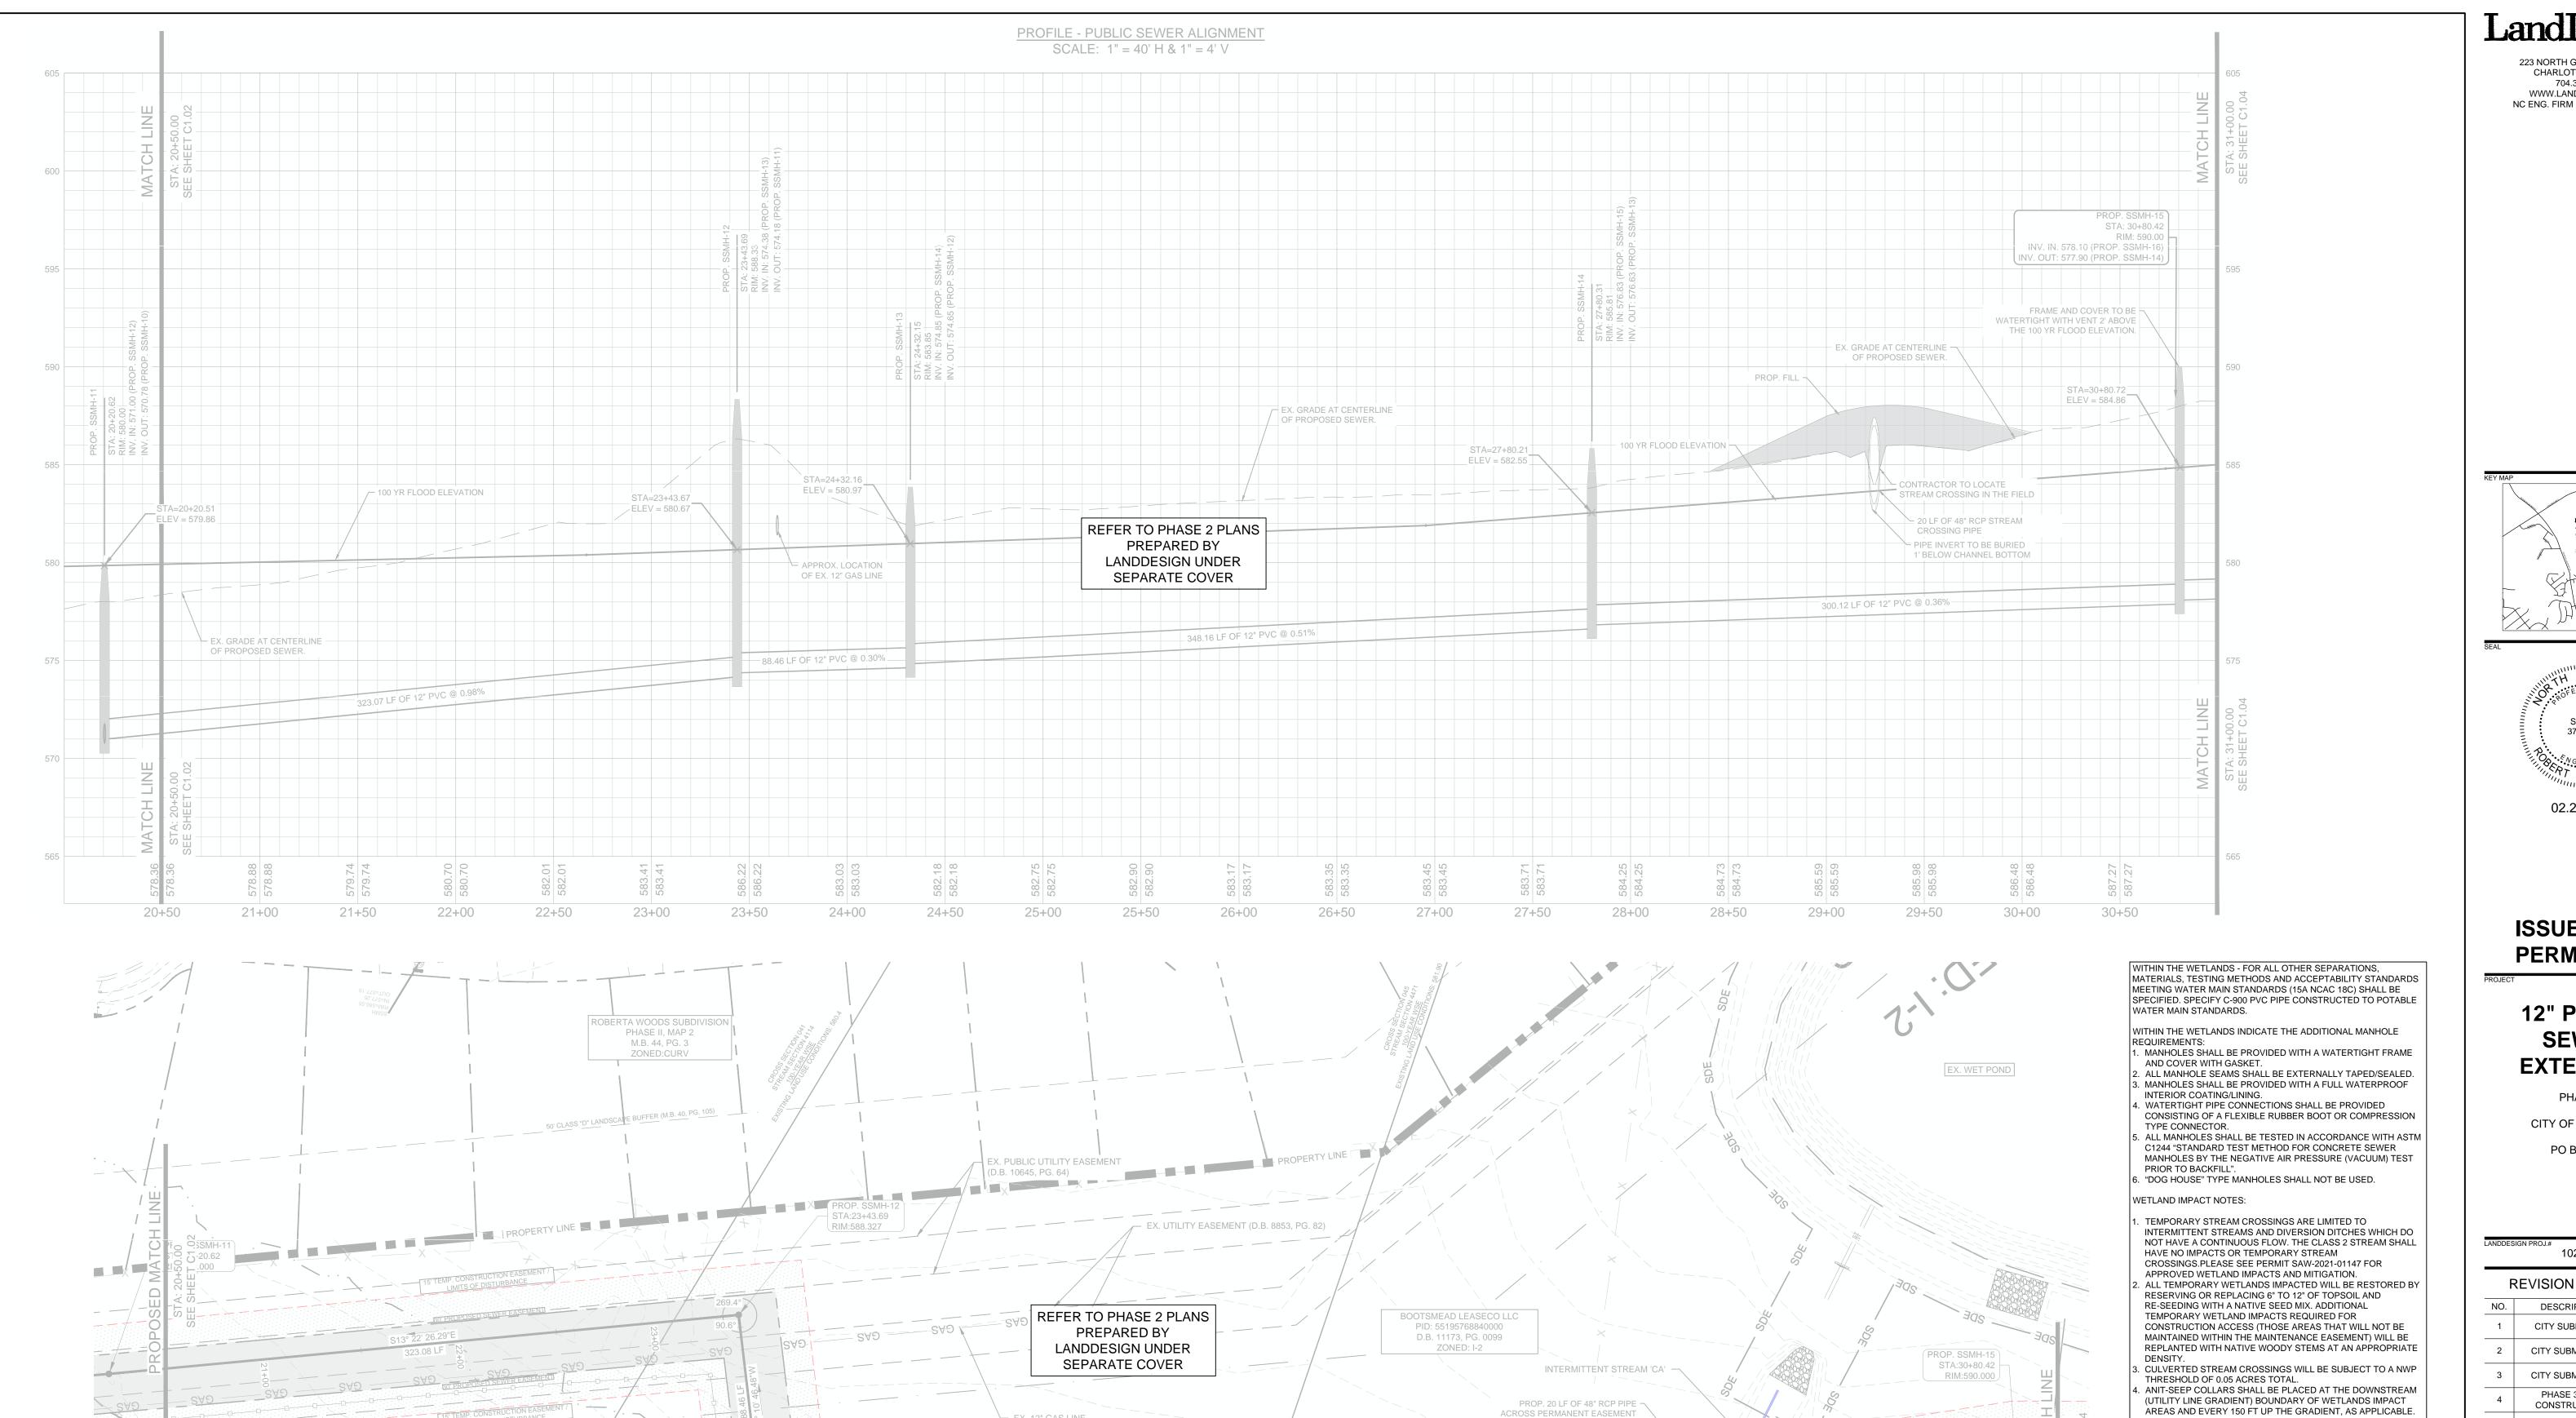






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F	REVISION / ISSU	JANCE
NO.	DESCRIPTION	DATE
1	CITY SUBMITTAL	09.01.2022
2	CITY SUBMITTAL 2	09.27.2022
3	CITY SUBMITTAL 3	03.10.2023
4	PHASE 3 FOR CONSTRUCTION	02.27.2024
	SIGNED BY: LDI	
	AWN BY: RSK	
СН	ECKED BY: RAK	





PROP. SSMH-14 STA:27+80.31

- EX. 12" GAS LINE

STA:24+32.15


CV NLA II LP


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P.B. 00081, PG, 00072

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223 NORTH GRAHAM STREET CHARLOTTE, NC 28202 704.333.0325 WWW.LANDDESIGN.COM NC ENG. FIRM LICENSE # C-0658



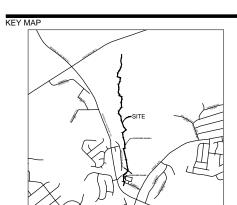

ISSUED FOR PERMITTING

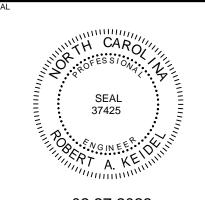12" PUBLIC **SEWER EXTENSION**

PHASE 3

CITY OF CONCORD PO BOX 308

1020059 REVISION / ISSUANCE DESCRIPTION CITY SUBMITTAL 09.01.2022 CITY SUBMITTAL 2 09.27.2022 CITY SUBMITTAL 3 03.10.2023 PHASE 3 FOR 02.27.2024 CONSTRUCTION DESIGNED BY: LDI DRAWN BY: RSK CHECKED BY: RAK

LEGEND

LIMITS OF DISTURBANCE (PH 2A - 3.56 AC) — — — —

TEMPORARY CONSTRUCTION EASEMENT

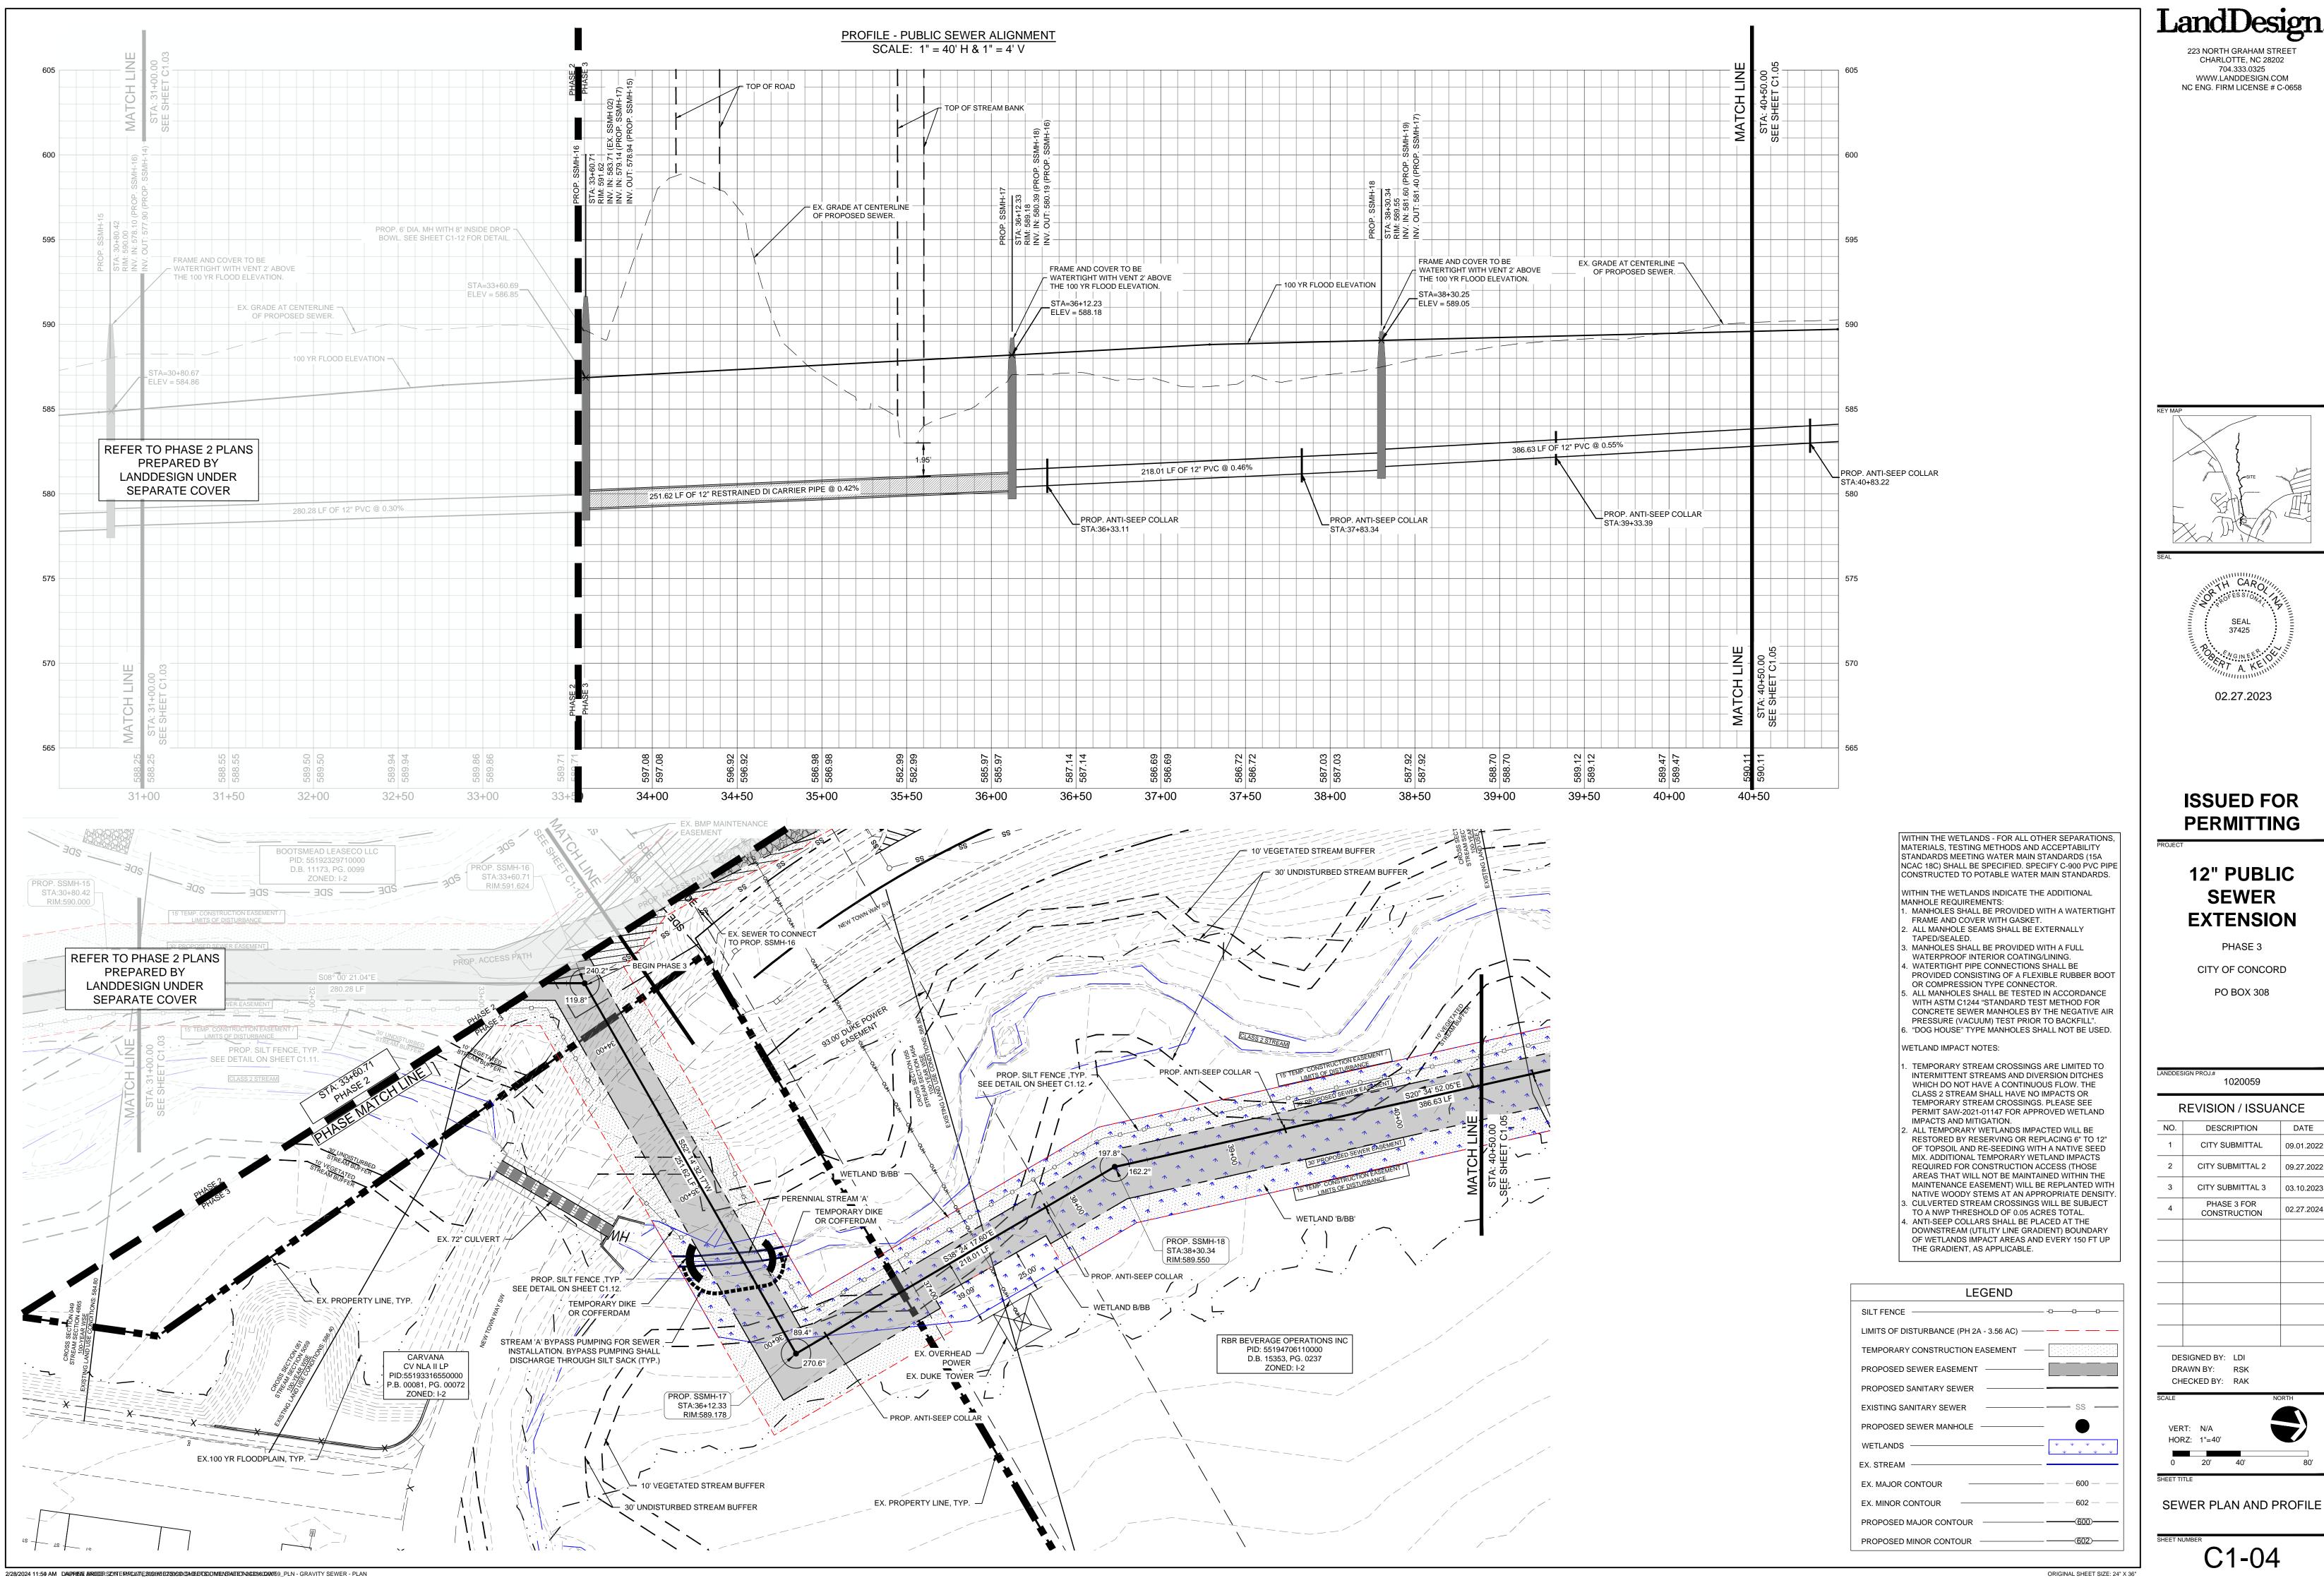
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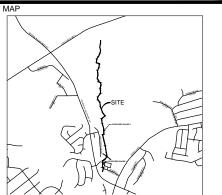
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EX. MINOR CONTOUR PROPOSED MAJOR CONTOUR


SEWER PLAN AND PROFILE -----(600)----

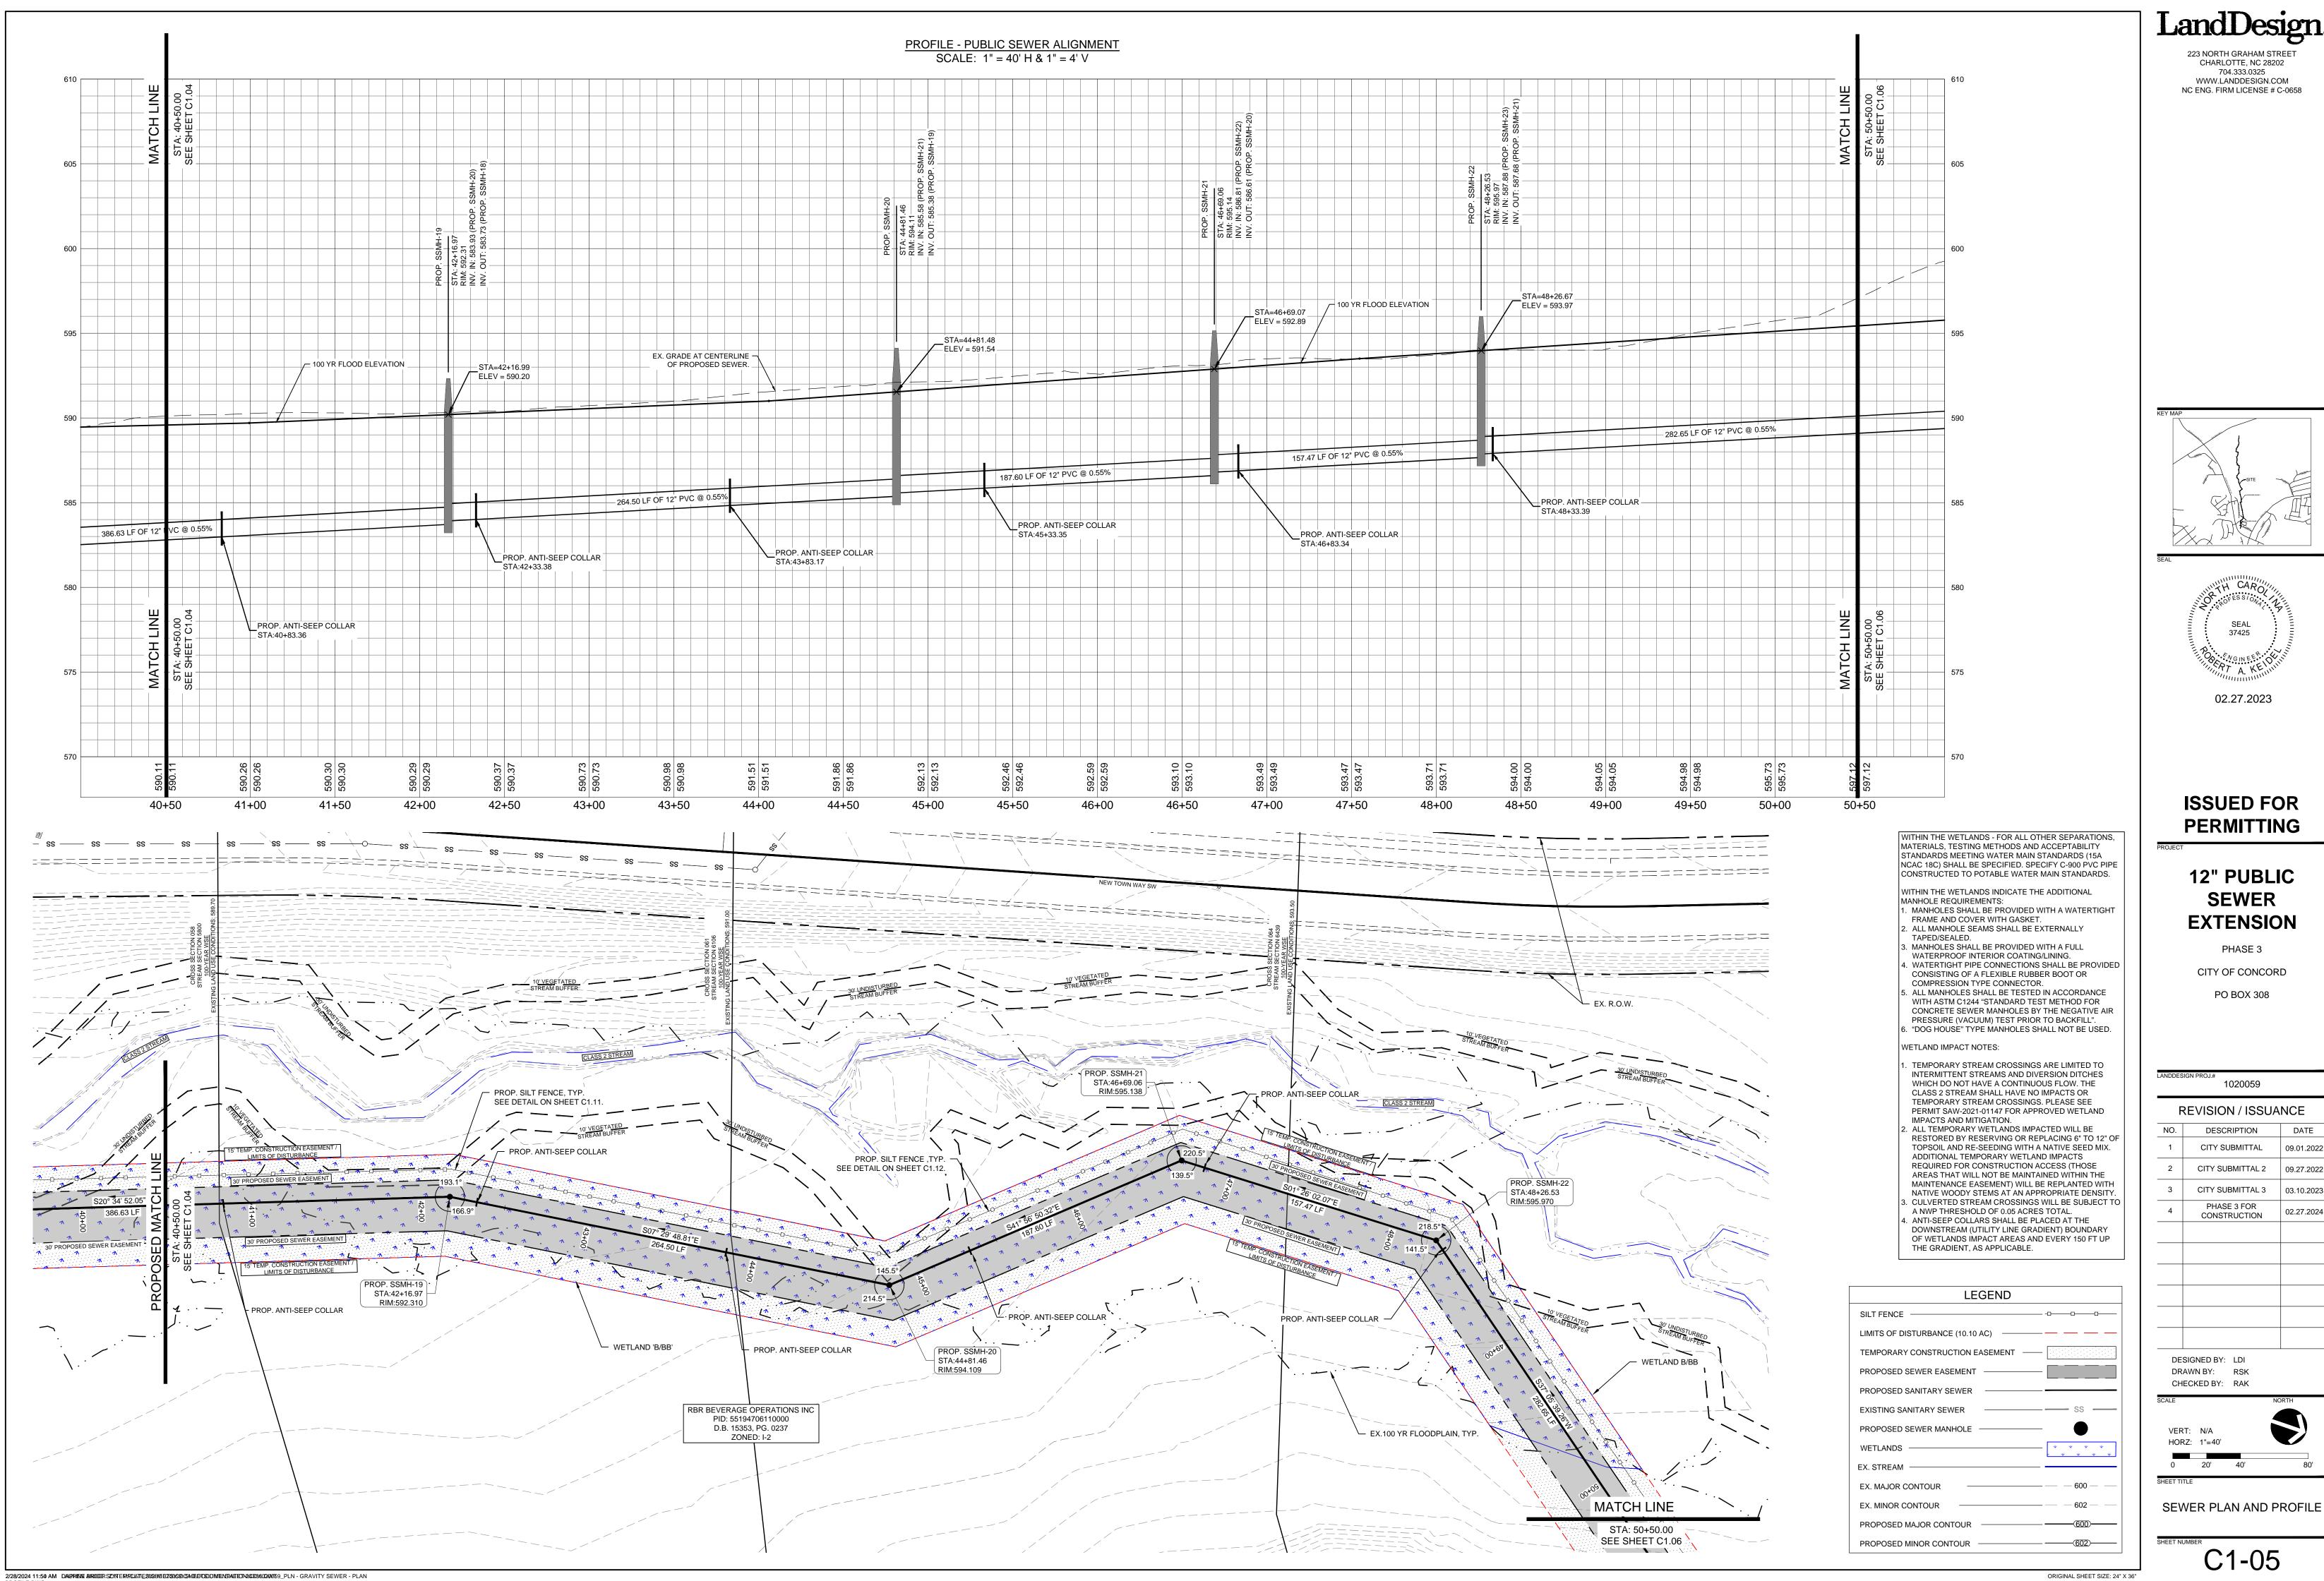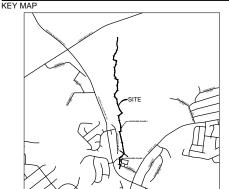
ORIGINAL SHEET SIZE: 24" X 36"





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l	SIGNED BY: LDI	
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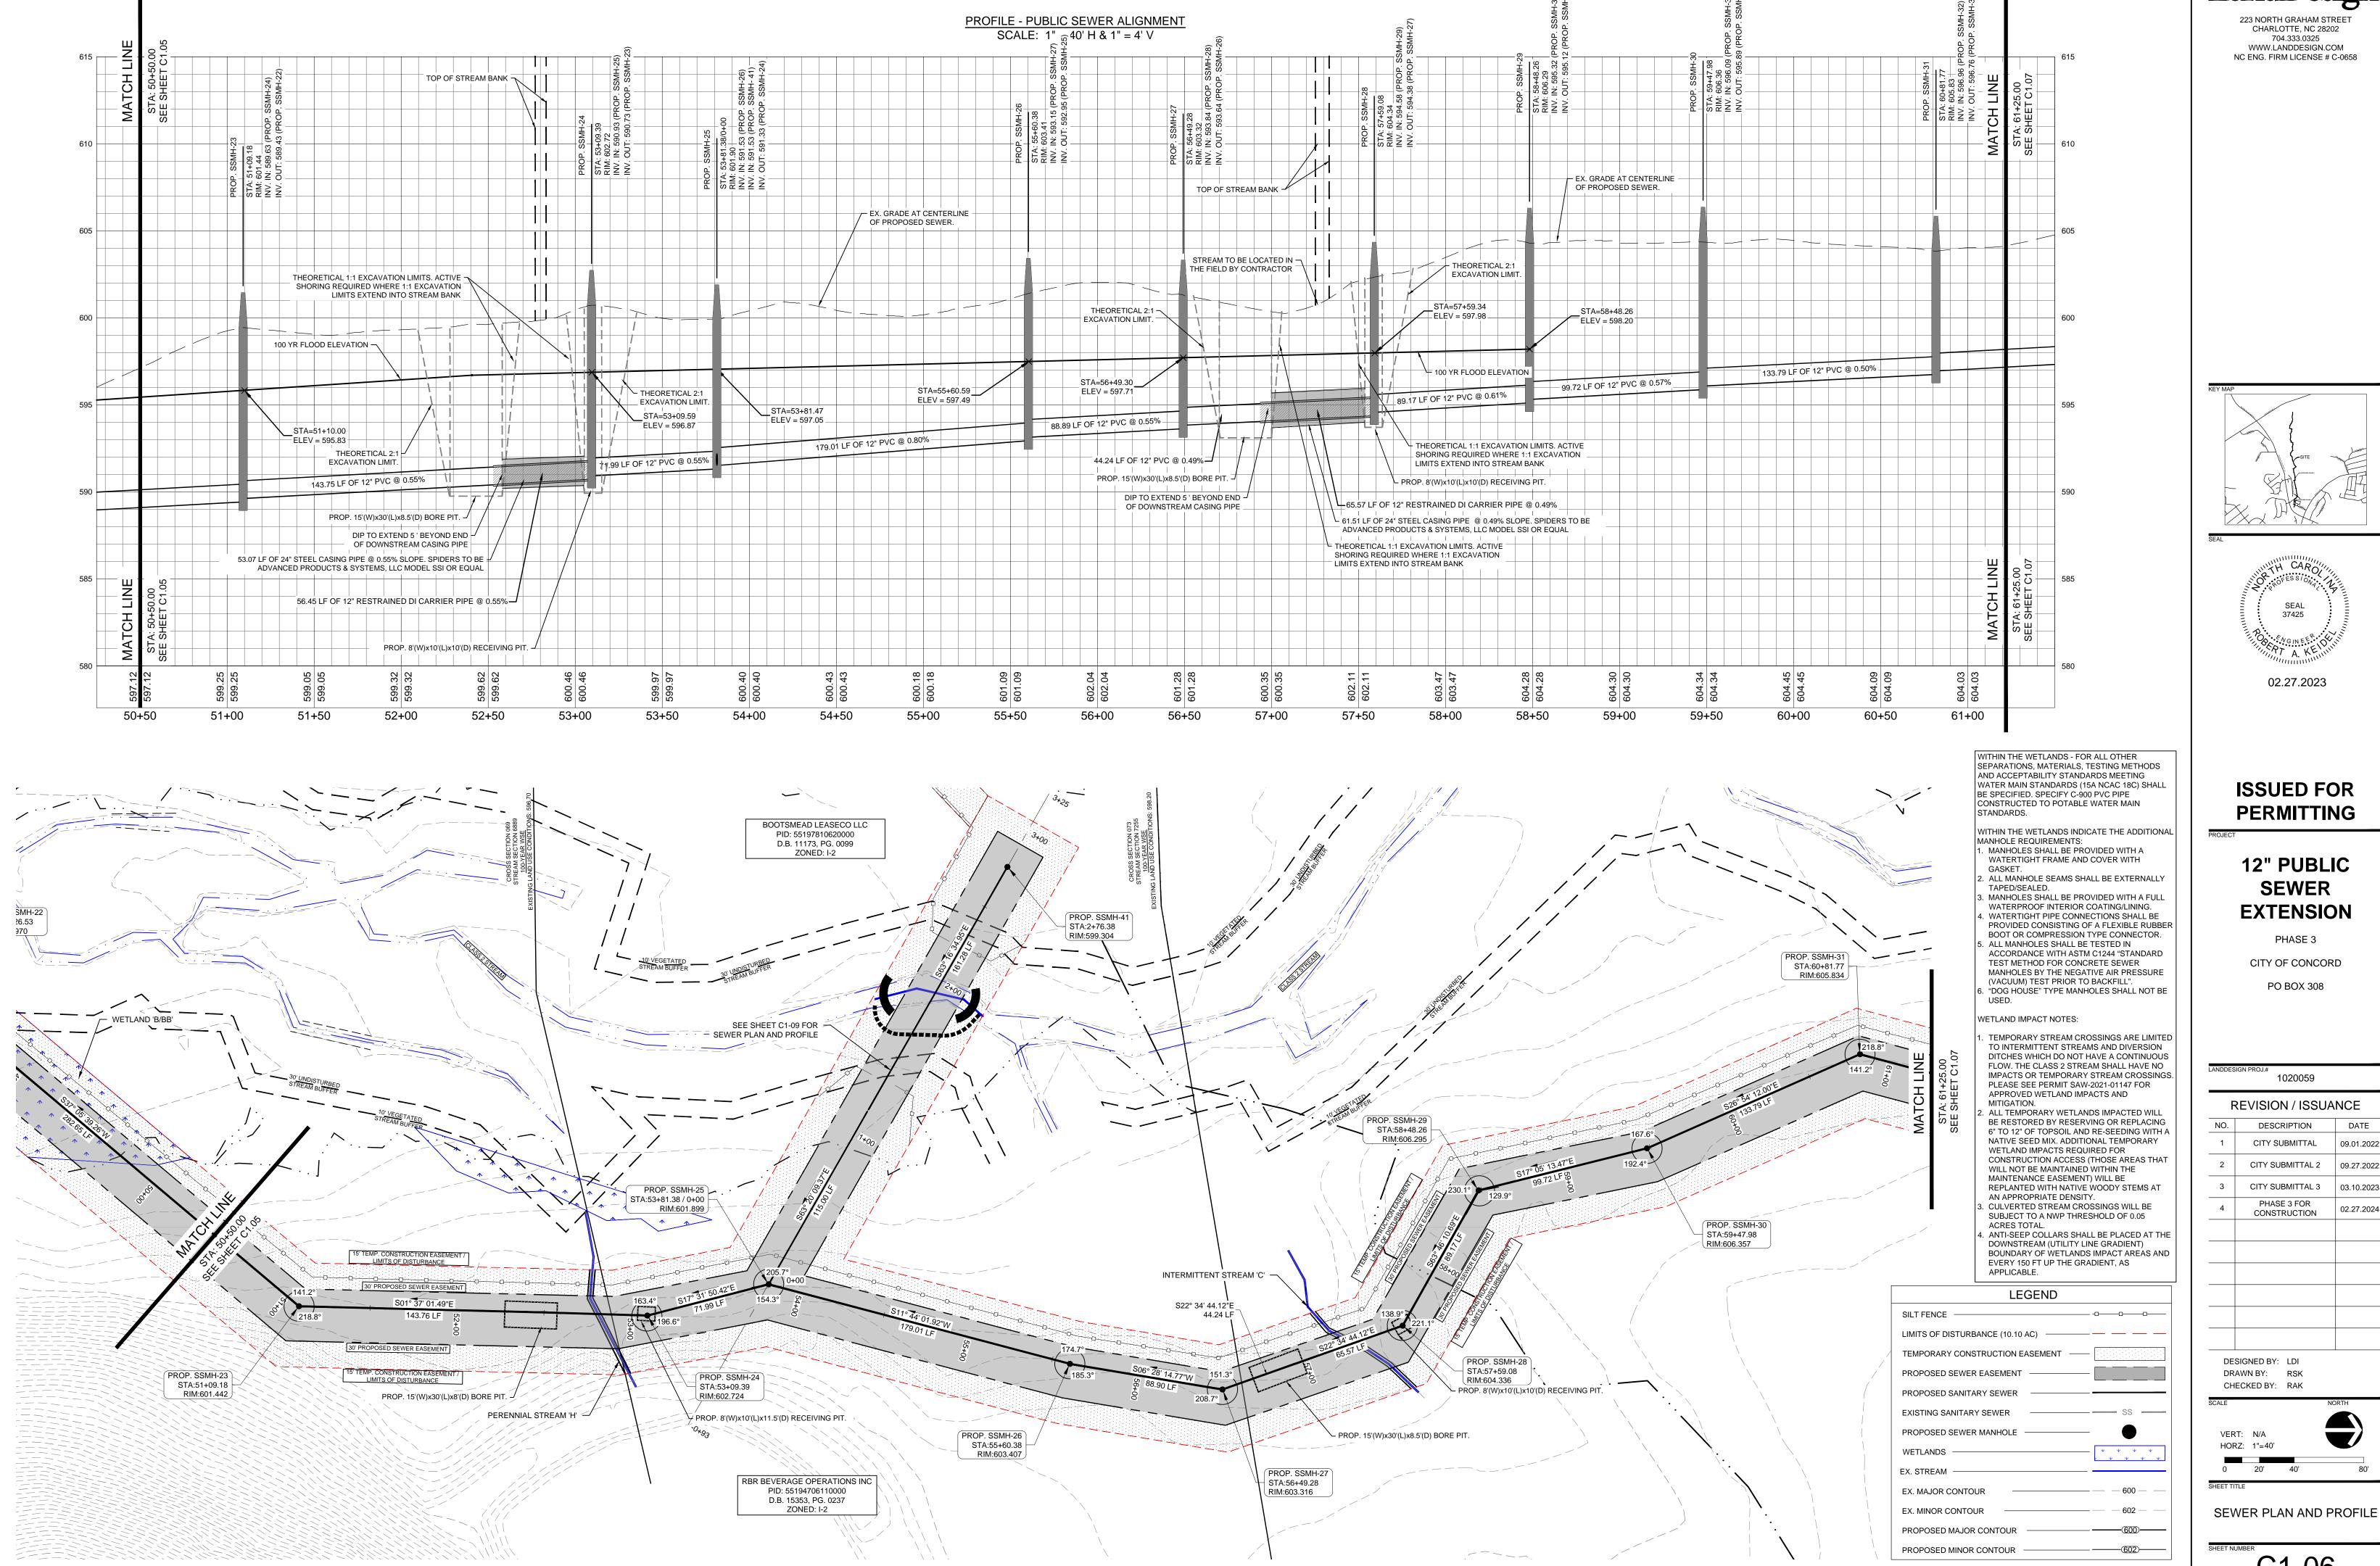







REVISION / ISSUANCE 09.01.2022

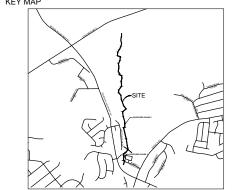09.27.2022 03.10.2023 02.27.2024






ANDDESIGN PROJ.# 1020059			
REVISION / ISSUANCE			
NO.	DESCRIPTION	DATE	
1	CITY SUBMITTAL	09.01.2022	
2	CITY SUBMITTAL 2	09.27.2022	
3	CITY SUBMITTAL 3	03.10.2023	
4	PHASE 3 FOR CONSTRUCTION	02.27.2024	


ORIGINAL SHEET SIZE: 24" X 36"

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12" PUBLIC SEWER EXTENSION

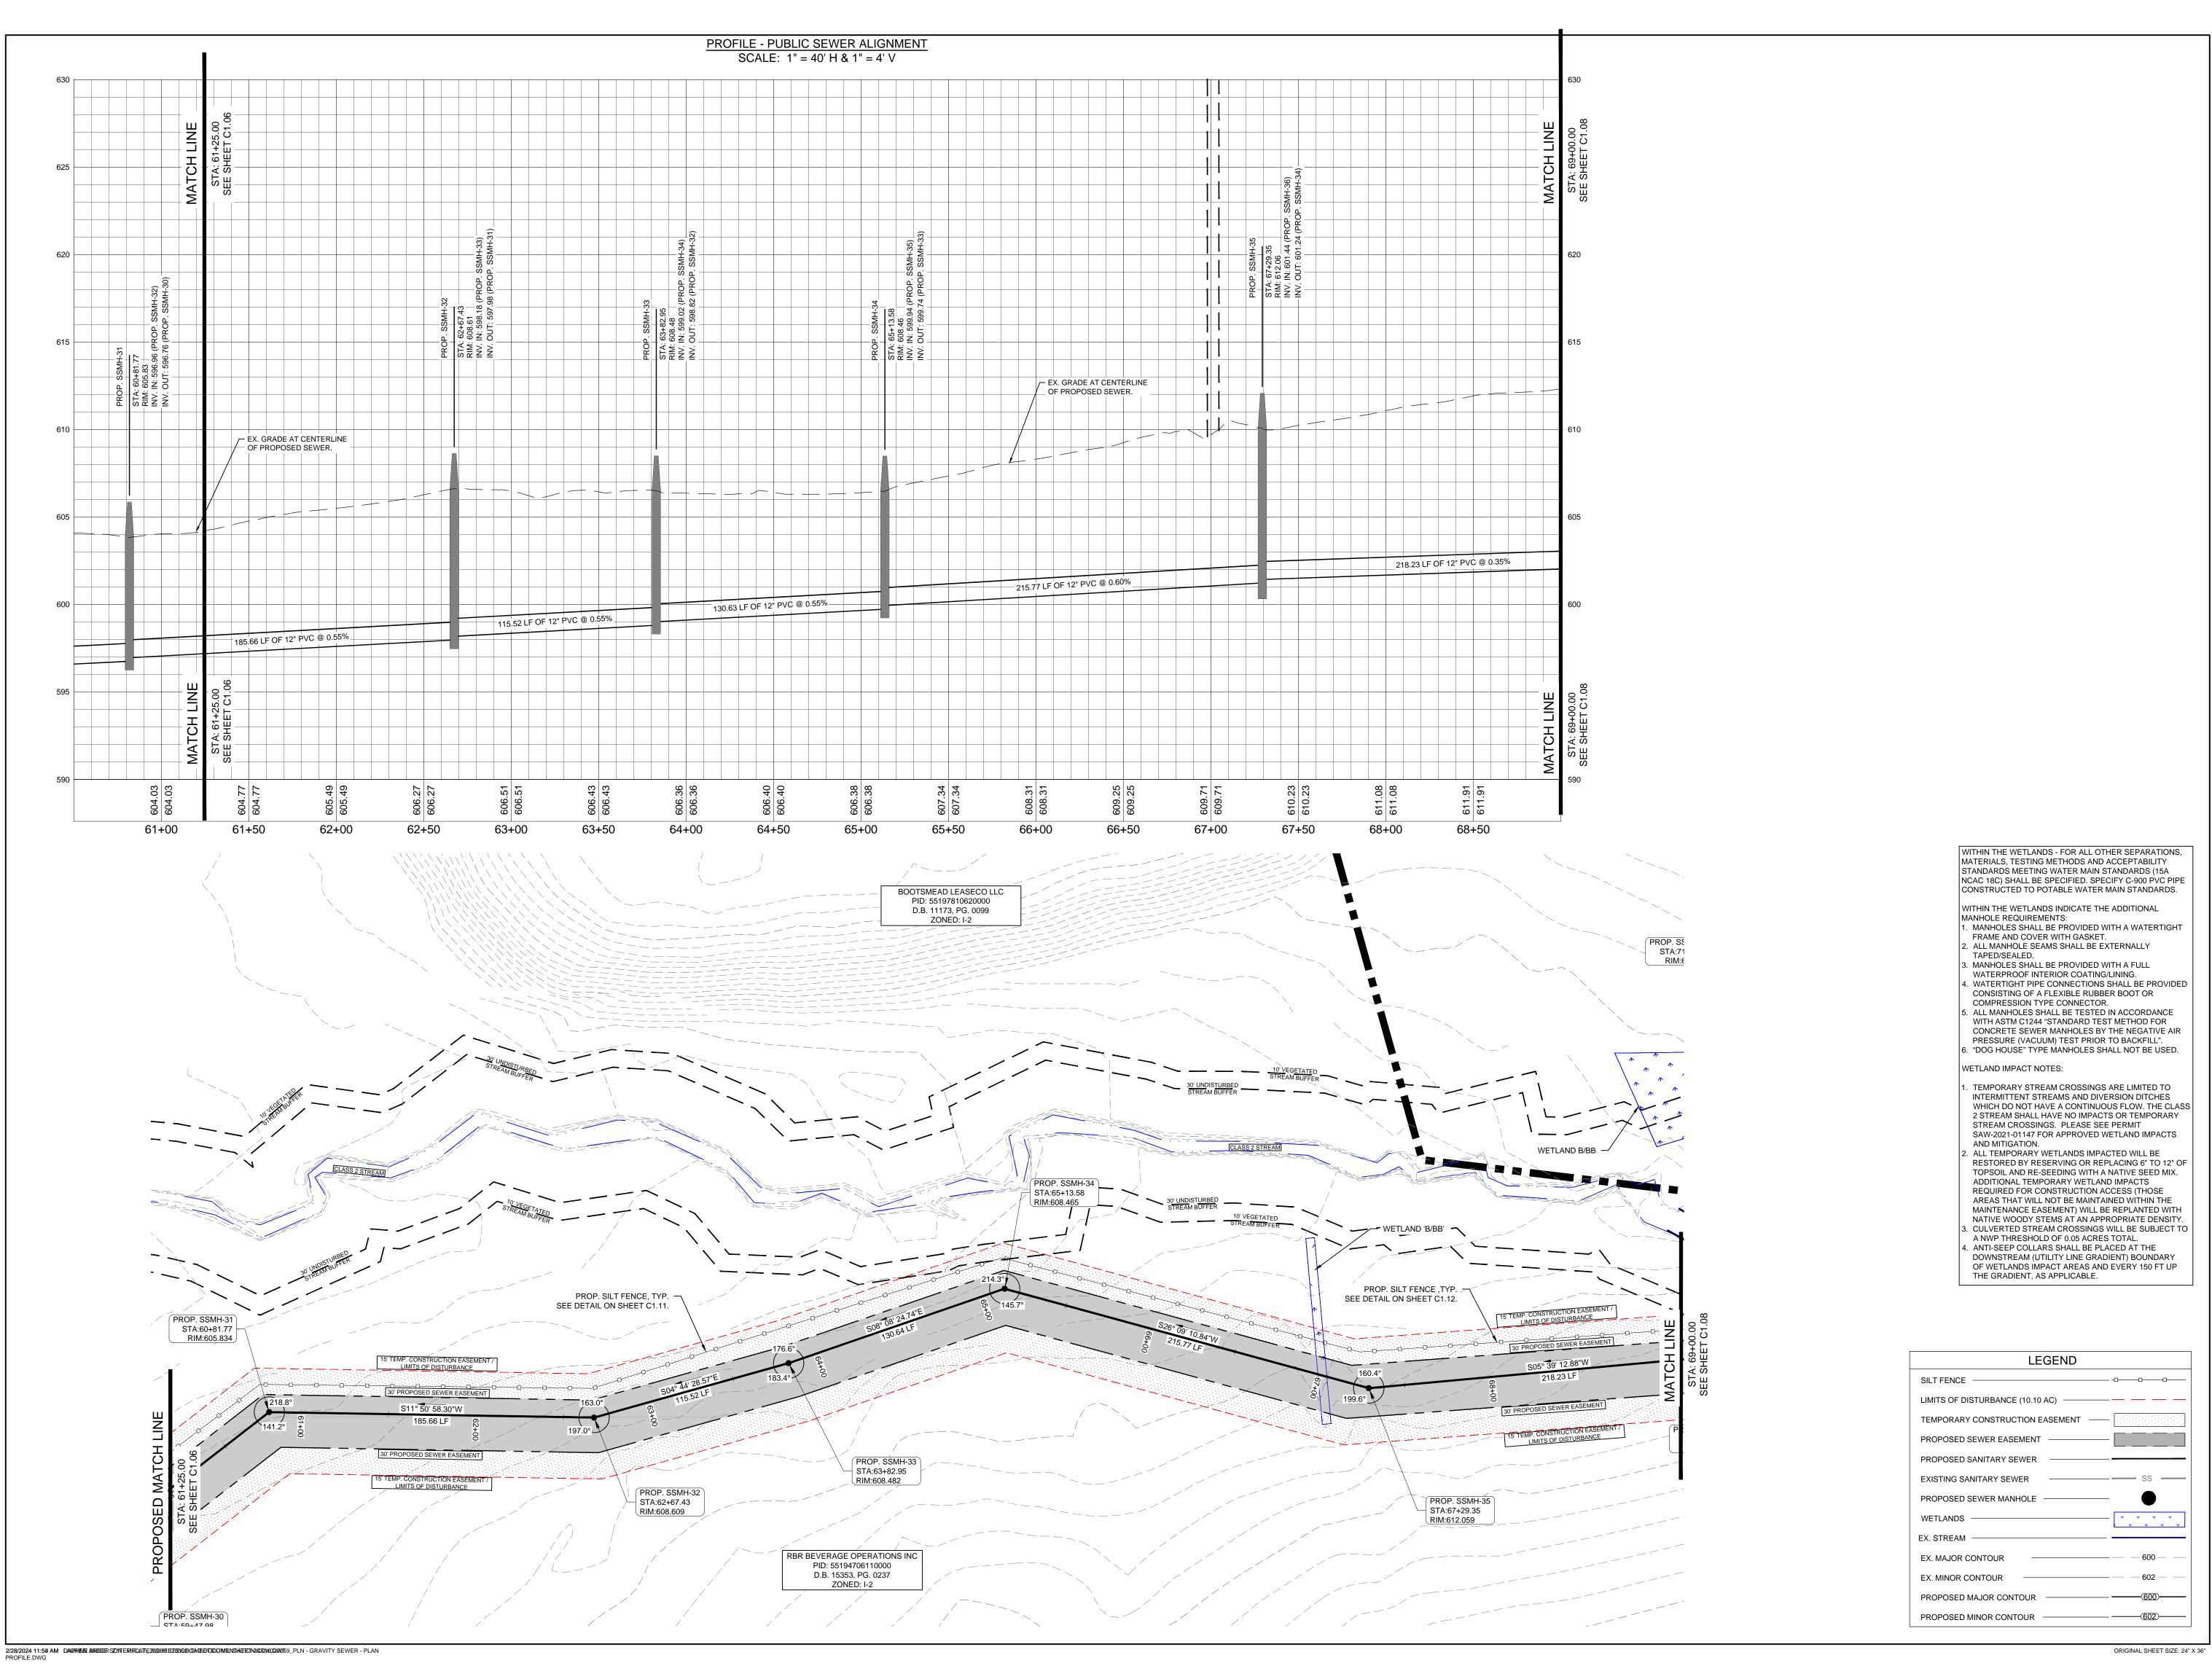
PHASE 3


PO BOX 308

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C1-07

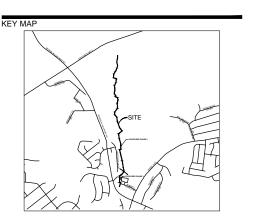SEWER PLAN AND PROFILE



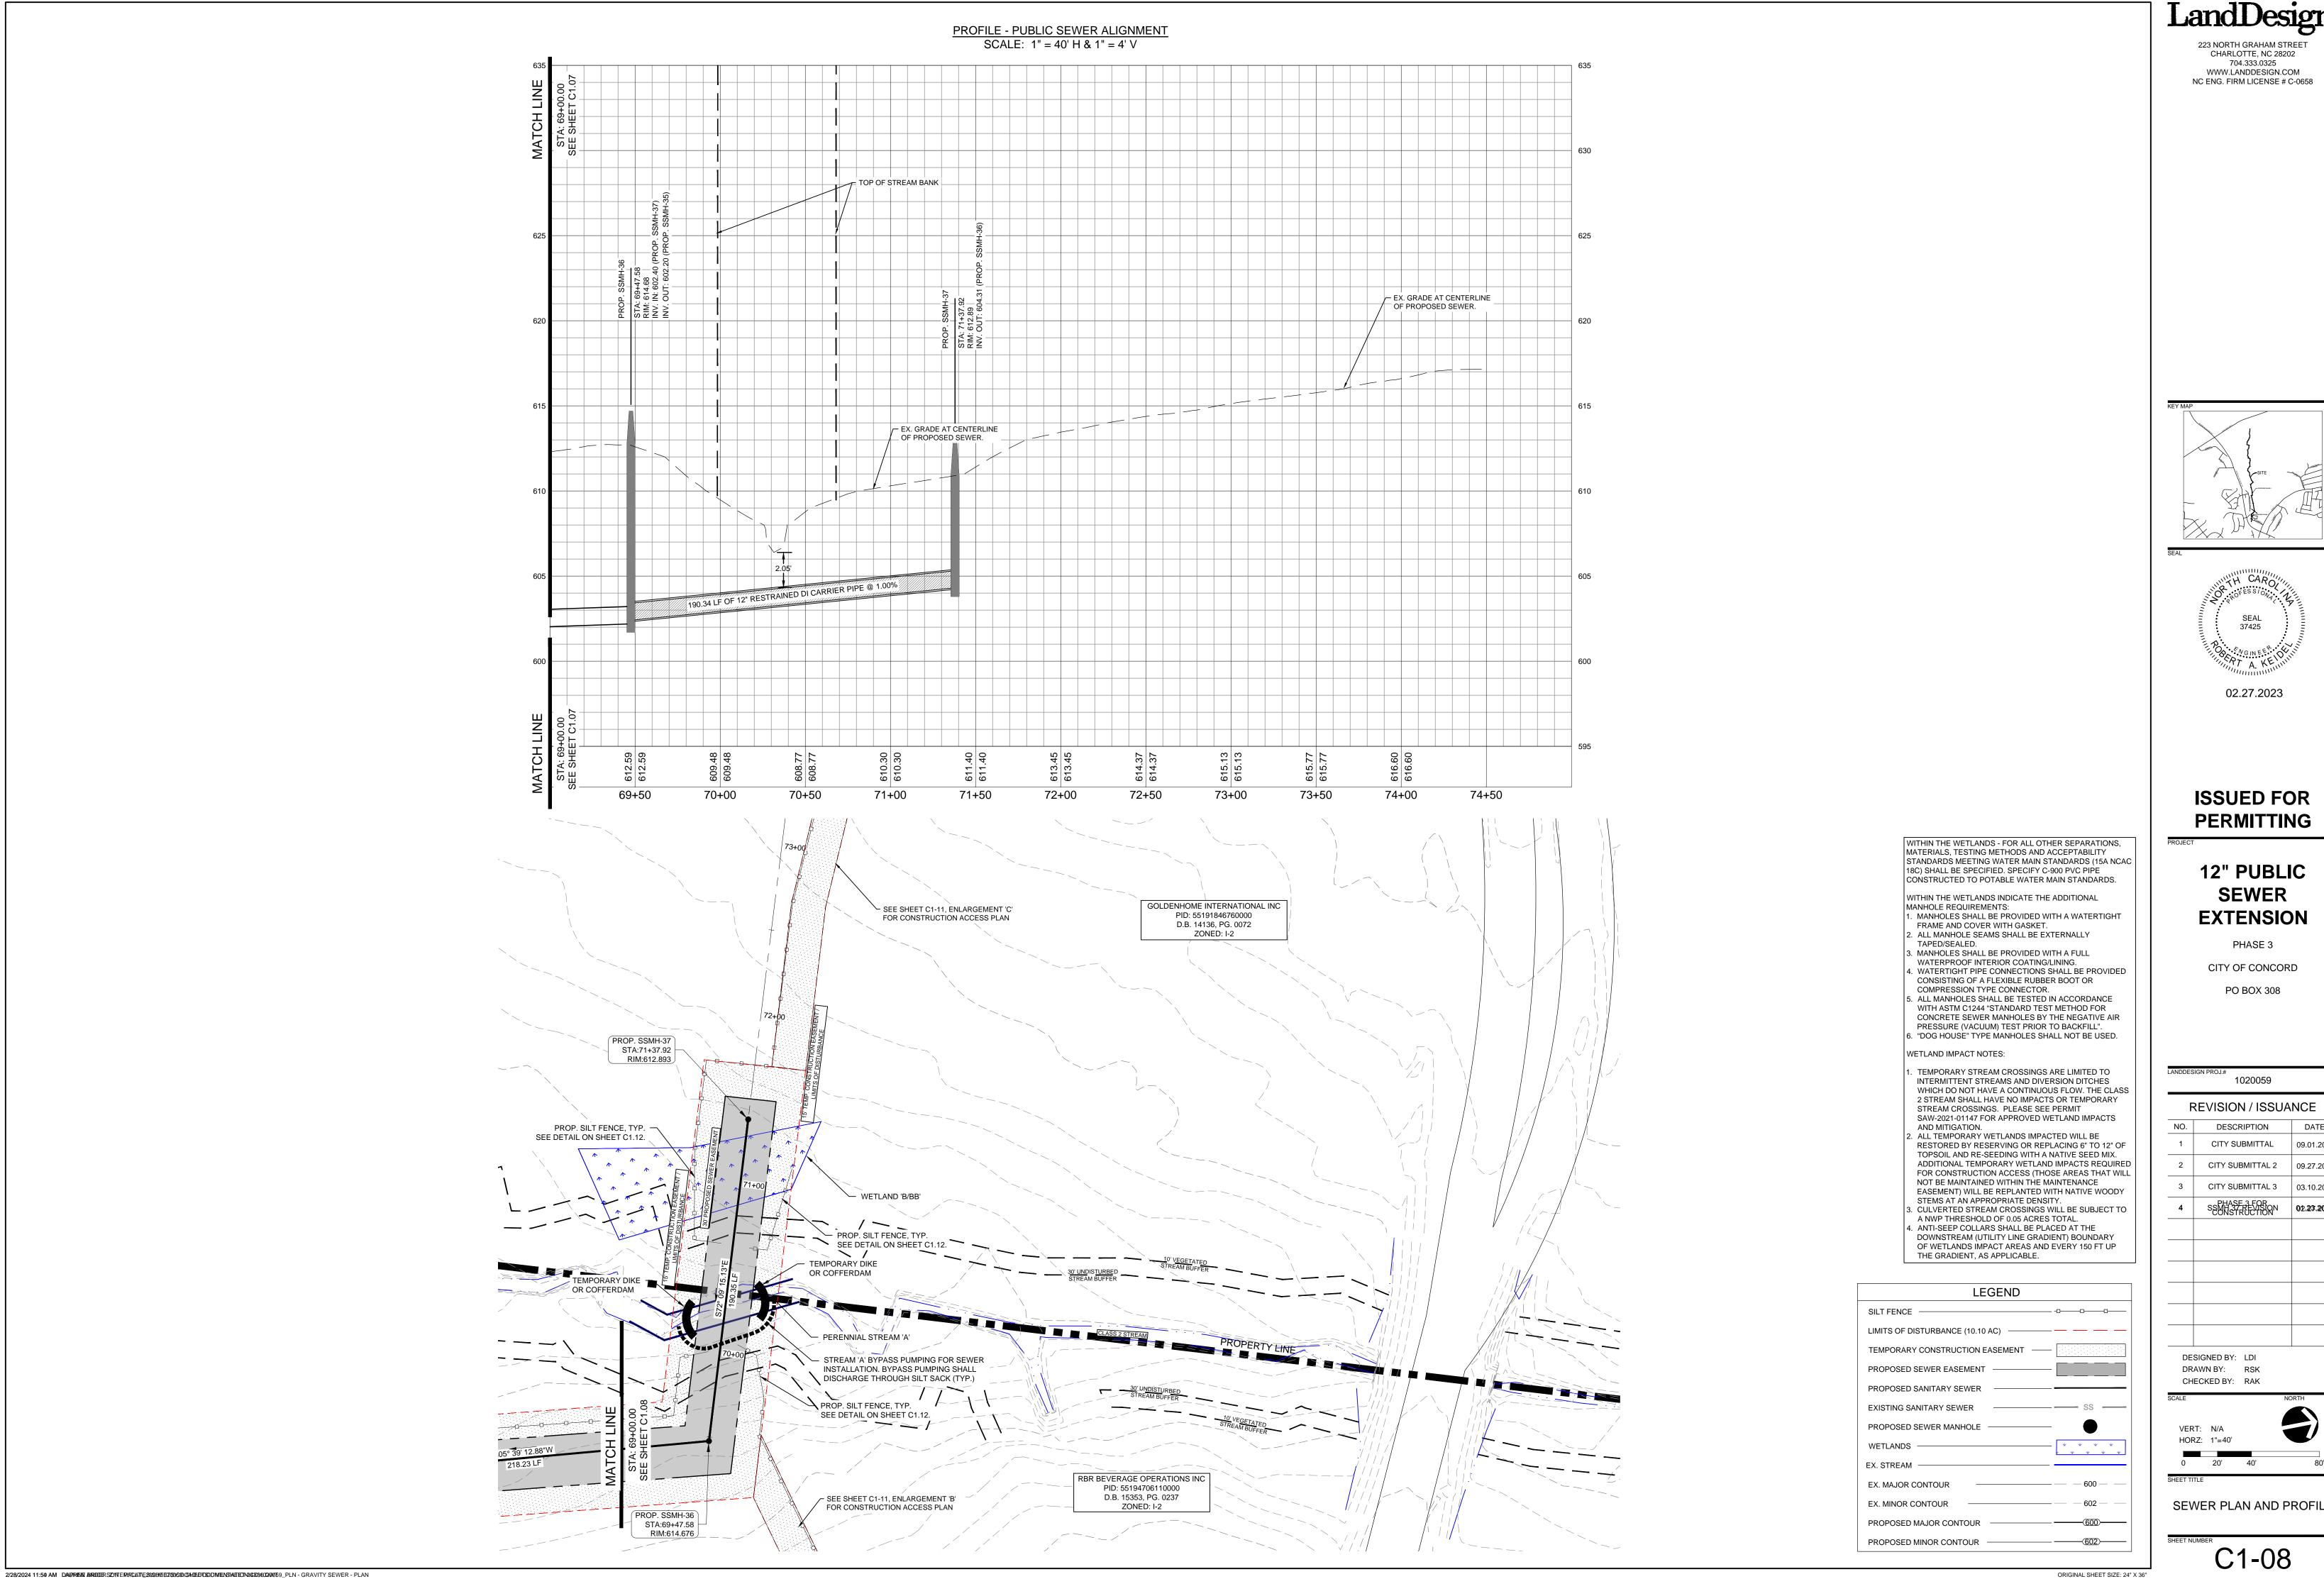


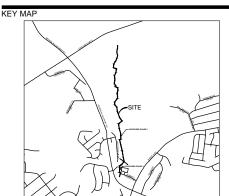


ANDDESI	GN PROJ.# 1020059	
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NO.	DESCRIPTION	DATE
1	CITY SUBMITTAL	09.01.2022
2	CITY SUBMITTAL 2	09.27.2022
3	CITY SUBMITTAL 3	03.10.2023
4	SEMASE 3 FOR ON	02.23.2024

SEWER PLAN AND PROFILE

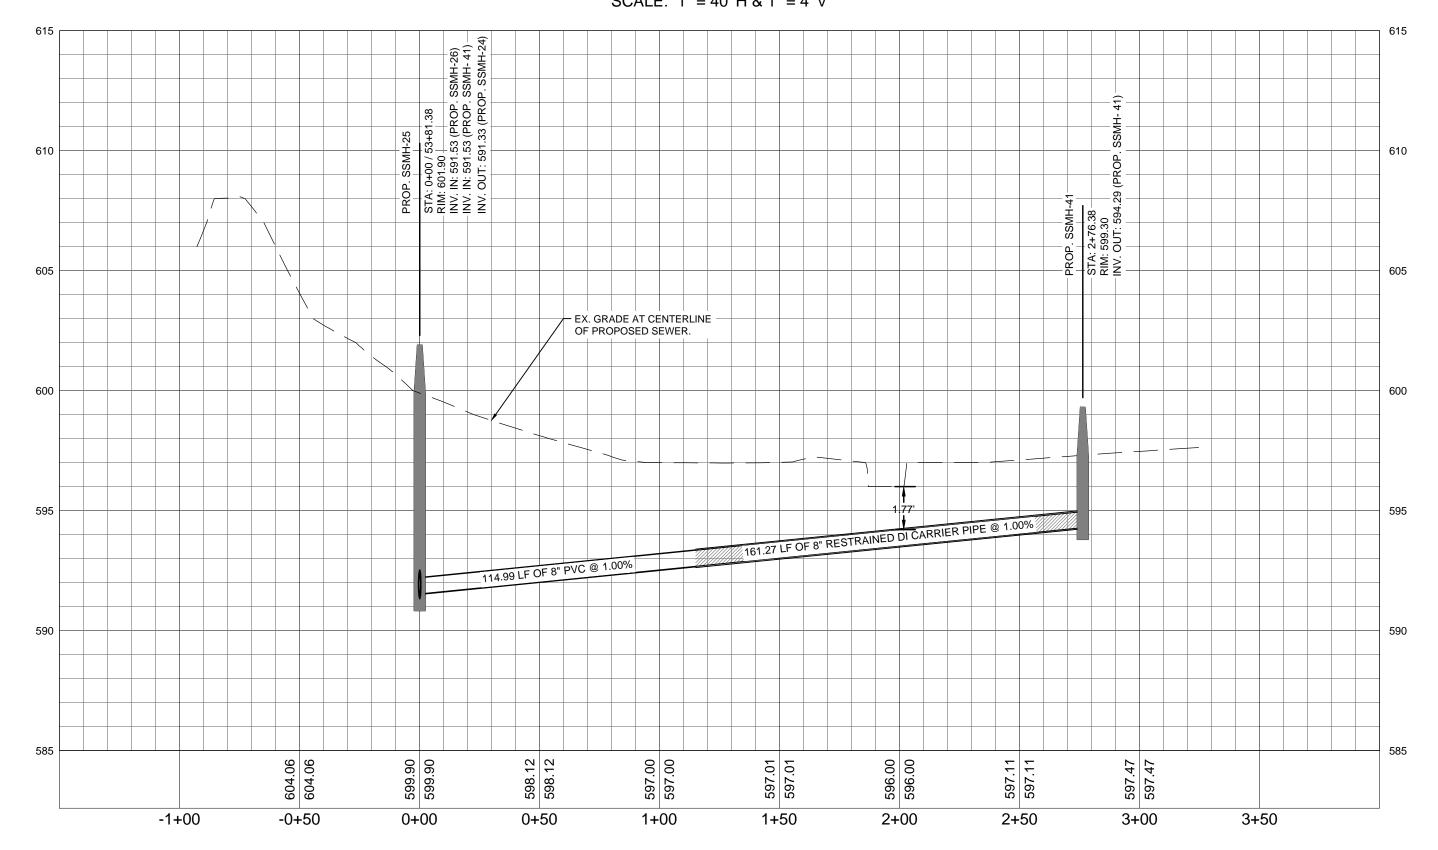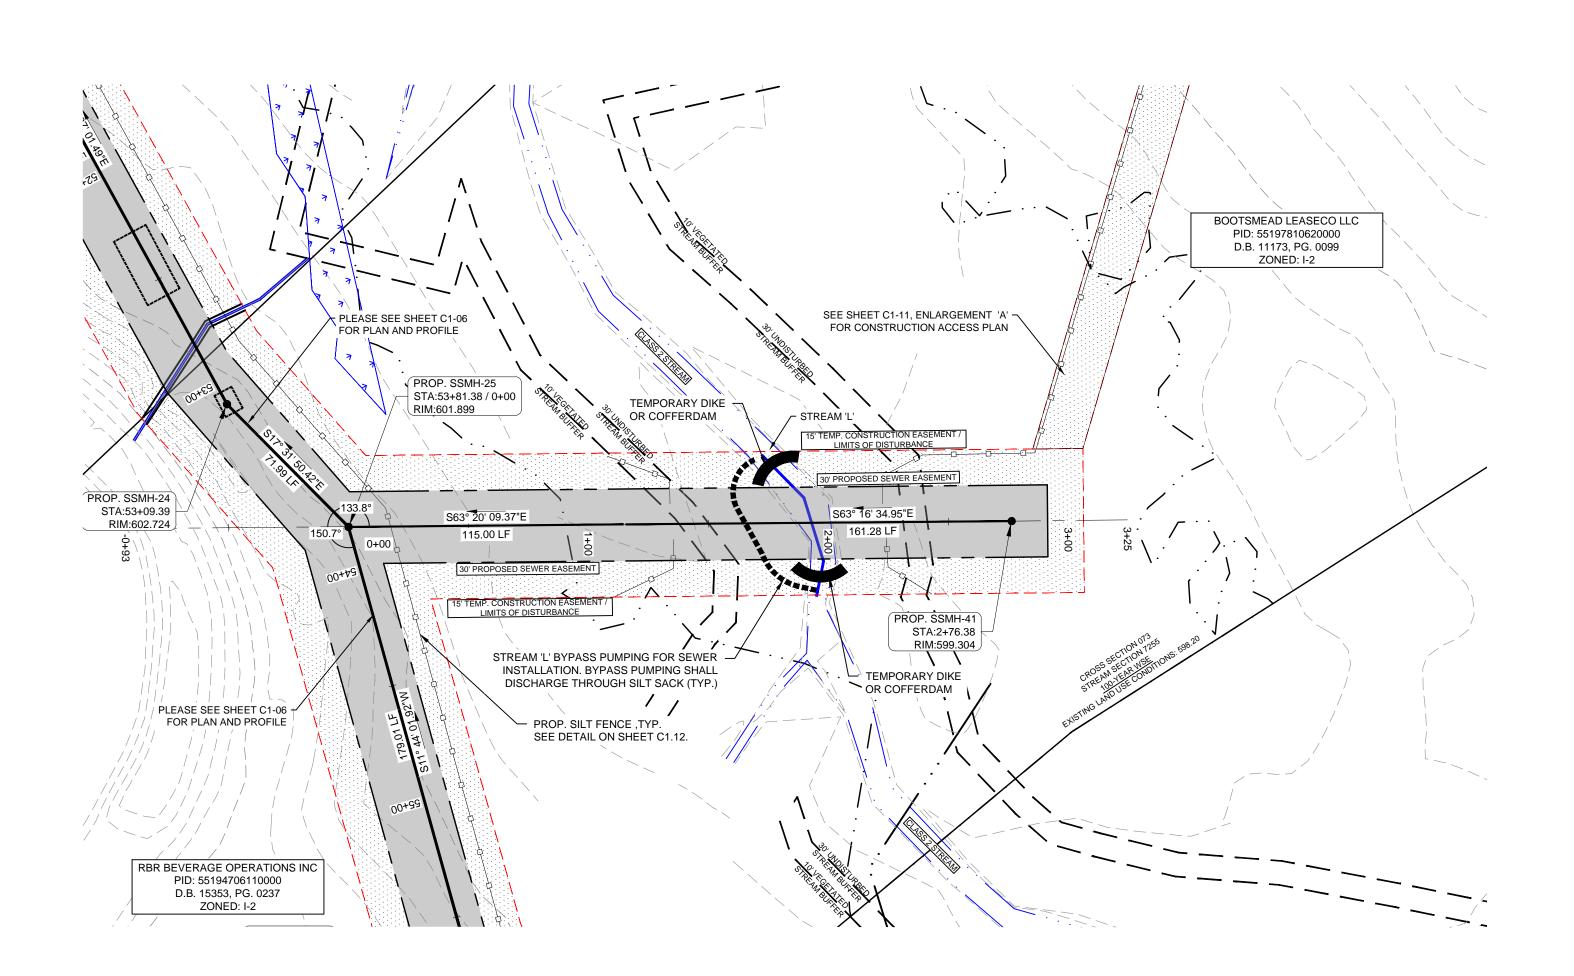
PROFILE - PUBLIC SEWER LATERAL SCALE: 1" = 40' H & 1" = 4' V






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02.27.2023

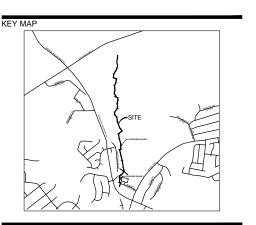WITHIN THE WETLANDS - FOR ALL OTHER SEPARATIONS, MATERIALS, TESTING METHODS AND ACCEPTABILITY STANDARDS MEETING WATER MAIN STANDARDS (15A NCAC 18C) SHALL BE SPECIFIED. SPECIFY C-900 PVC PIPE CONSTRUCTED TO POTABLE WATER MAIN STANDARDS.

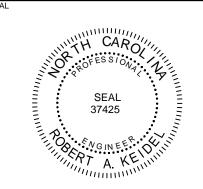WITHIN THE WETLANDS INDICATE THE ADDITIONAL MANHOLE REQUIREMENTS:

- MANHOLES SHALL BE PROVIDED WITH A WATERTIGHT FRAME AND COVER WITH GASKET.
- 2. ALL MANHOLE SEAMS SHALL BE EXTERNALLY TAPED/SEALED.
- 3. MANHOLES SHALL BE PROVIDED WITH A FULL WATERPROOF INTERIOR COATING/LINING.
- 4. WATERTIGHT PIPE CONNECTIONS SHALL BE PROVIDED CONSISTING OF A FLEXIBLE RUBBER BOOT OR
- COMPRESSION TYPE CONNECTOR.

 5. ALL MANHOLES SHALL BE TESTED IN ACCORDANCE WITH ASTM C1244 "STANDARD TEST METHOD FOR
- WITH ASTM C1244 "STANDARD TEST METHOD FOR CONCRETE SEWER MANHOLES BY THE NEGATIVE AIR PRESSURE (VACUUM) TEST PRIOR TO BACKFILL".

 6. "DOG HOUSE" TYPE MANHOLES SHALL NOT BE USED.

WETLAND IMPACT NOTES:

I. TEMPORARY STREAM CROSSINGS ARE LIMITED TO INTERMITTENT STREAMS AND DIVERSION DITCHES WHICH DO NOT HAVE A CONTINUOUS FLOW. THE CLASS 2 STREAM SHALL HAVE NO IMPACTS OR TEMPORARY STREAM CROSSINGS. PLEASE SEE PERMIT SAW-2021-01147 FOR APPROVED WETLAND IMPACTS AND MITIGATION.

2. ALL TEMPORARY WETLANDS IMPACTED WILL BE RESTORED BY RESERVING OR REPLACING 6" TO 12" OF TOPSOIL AND RE-SEEDING WITH A NATIVE SEED MIX. ADDITIONAL TEMPORARY WETLAND IMPACTS REQUIRED FOR CONSTRUCTION ACCESS (THOSE AREAS THAT WILL NOT BE MAINTAINED WITHIN THE MAINTENANCE EASEMENT) WILL BE REPLANTED WITH NATIVE WOODY STEMS AT AN APPROPRIATE DENSITY.

3. CULVERTED STREAM CROSSINGS WILL BE SUBJECT TO A NWP THRESHOLD OF 0.05 ACRES TOTAL.

4. ANTI-SEEP COLLARS SHALL BE PLACED AT THE DOWNSTREAM (UTILITY LINE GRADIENT) BOUNDARY OF WETLANDS IMPACT AREAS AND EVERY 150 FT UP THE GRADIENT, AS APPLICABLE.

LEGEND	
SILT FENCE	
LIMITS OF DISTURBANCE (10.10 AC)	
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PROPOSED SEWER EASEMENT —————	
PROPOSED SANITARY SEWER -	
EXISTING SANITARY SEWER	ss
PROPOSED SEWER MANHOLE -	_ •
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EX. MINOR CONTOUR	<u> </u>
PROPOSED MAJOR CONTOUR —————	
PROPOSED MINOR CONTOUR	

ISSUED FOR PERMITTING

12" PUBLIC SEWER EXTENSION

PHASE 3
CITY OF CONCORD

PO BOX 308

DESIGNED BY: LDI
DRAWN BY: RSK
CHECKED BY: RAK

CALE

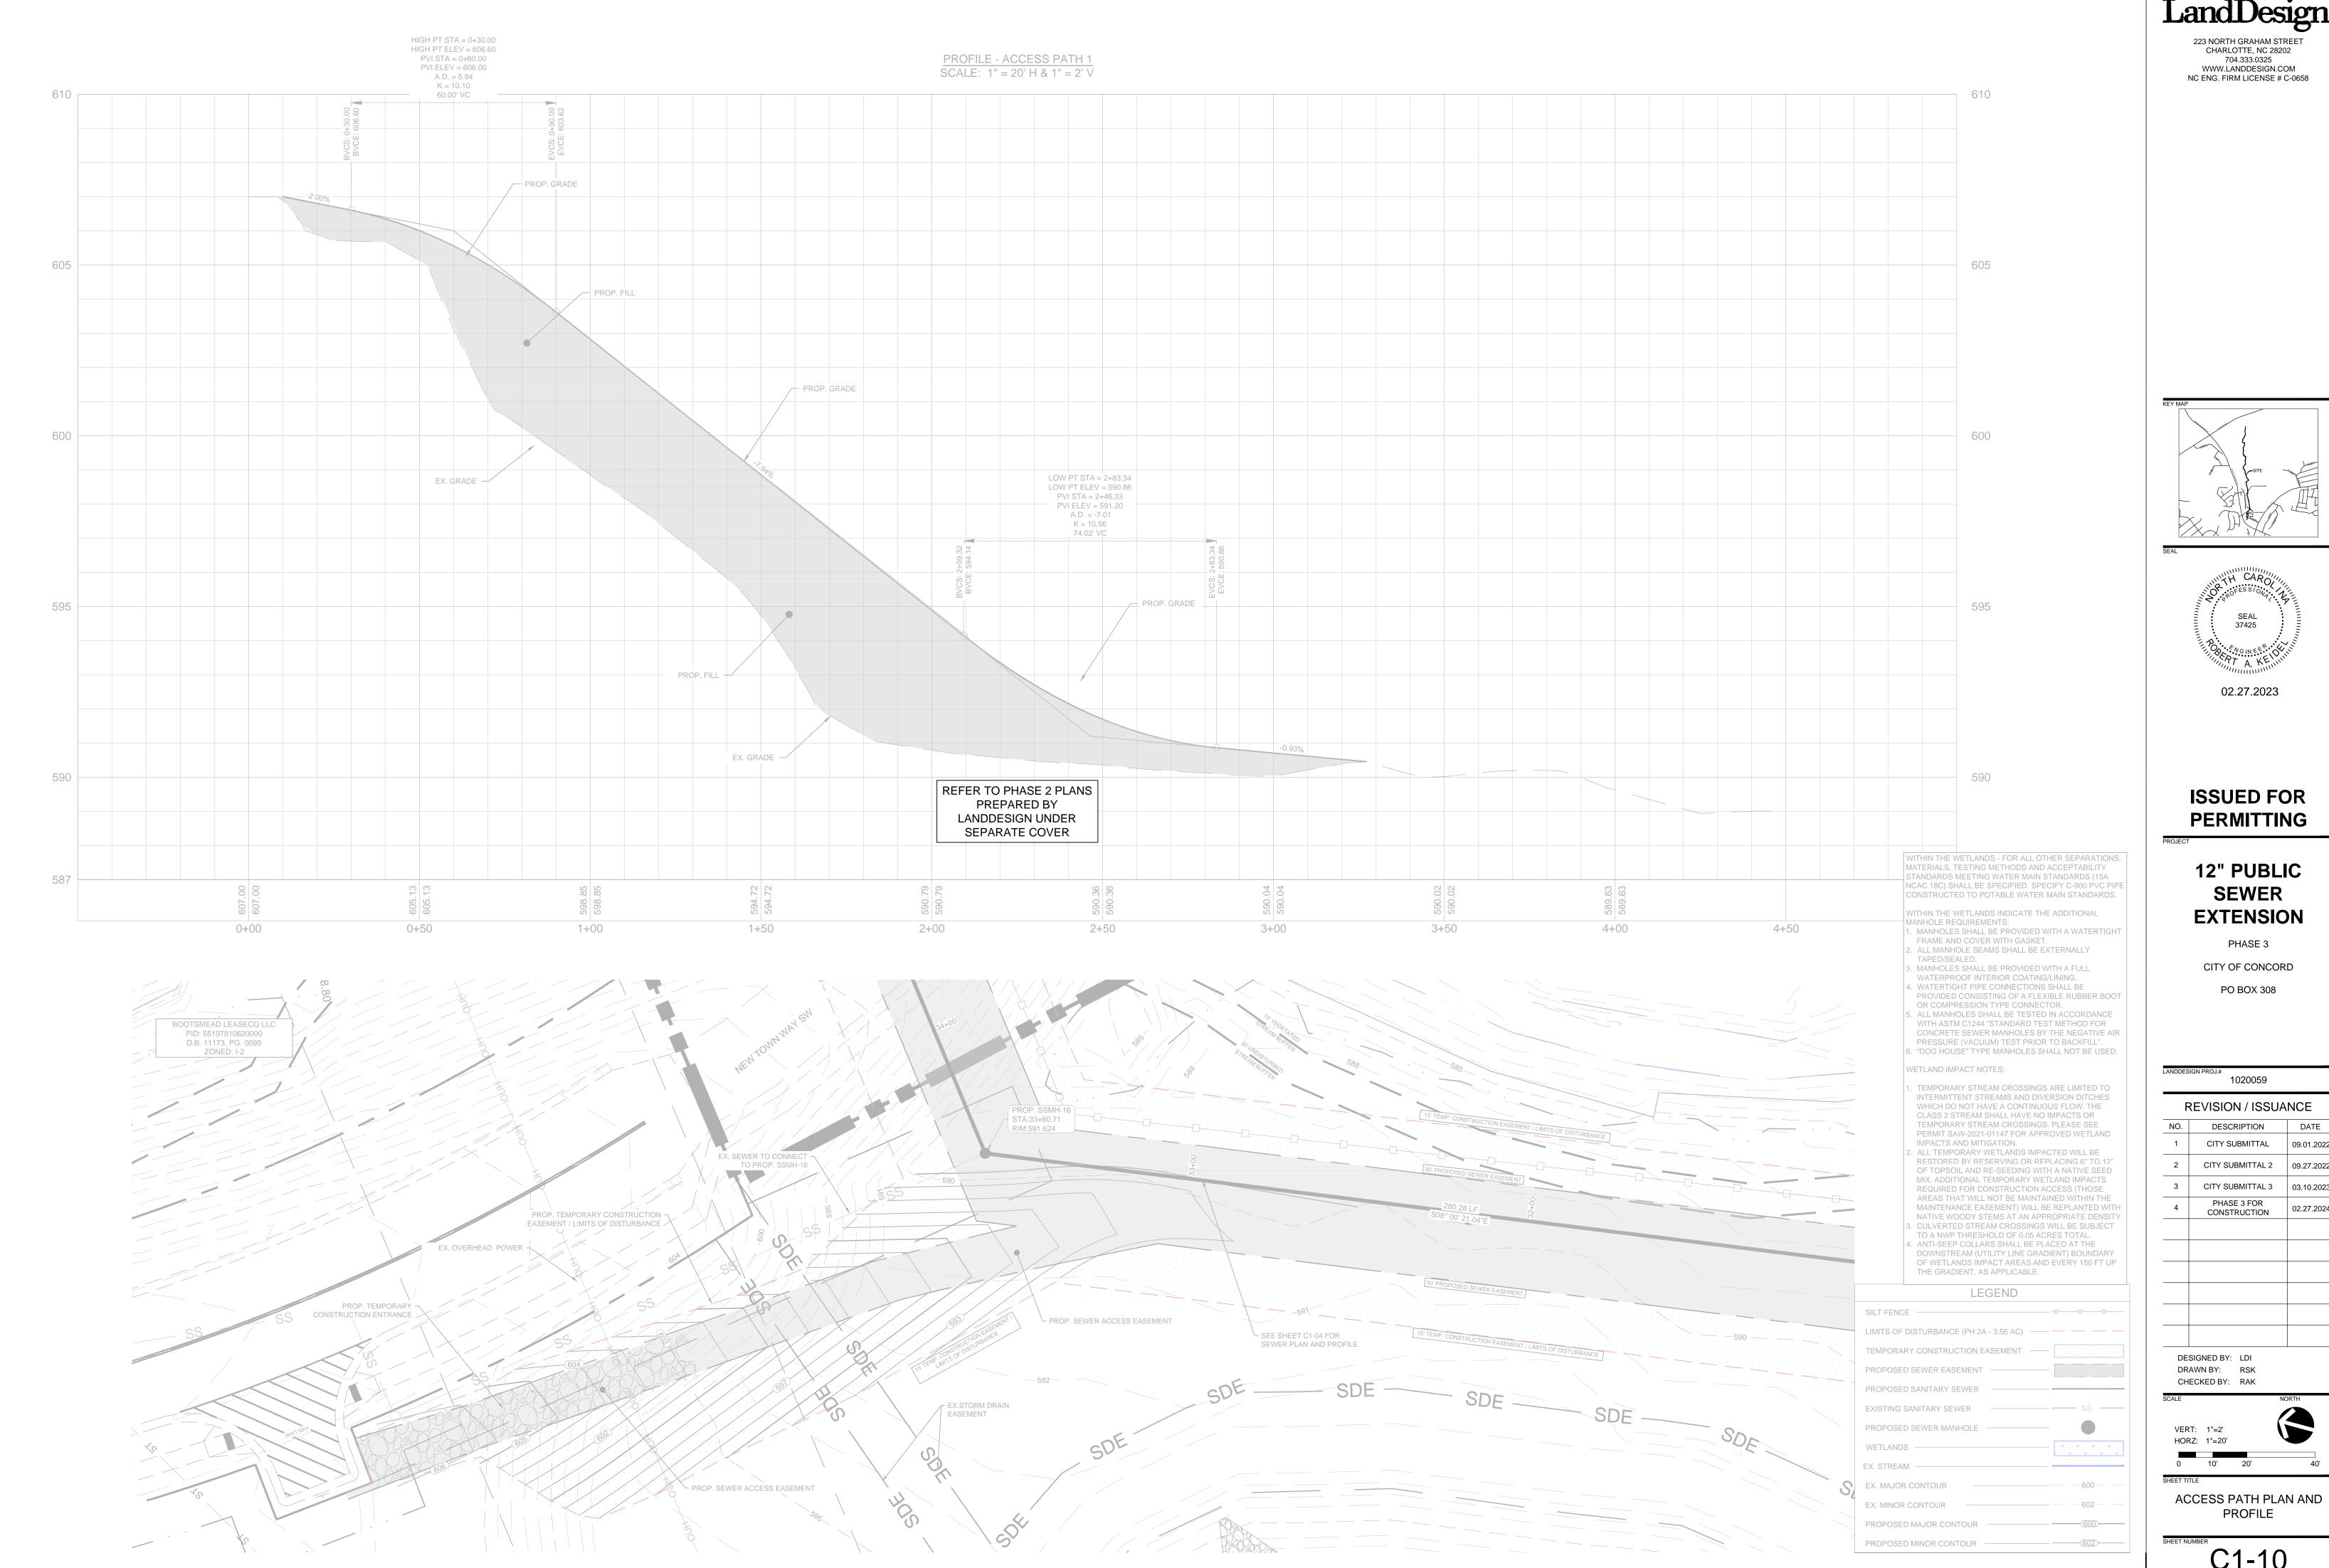
NORTH

VERT: 1"=4'
HORZ: 1"=40'


0 20' 40' 80'

SEWER PLAN AND PROFILE

C1 00



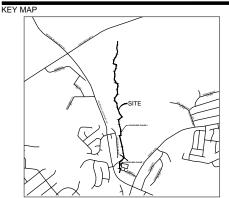
2/28/2024 11:89 AM DAUPRINE BRIDER SONTEMICLATE 2020HE 2/30/630(3ALBADDS) OM HINSHJEED RECKNOOL 200759_PLN - GRAVITY SEWER - ACCESS






REVISION / ISSUANCE 09.01.2022 CITY SUBMITTAL 2 09.27.2022 03.10.2023 02.27.2024

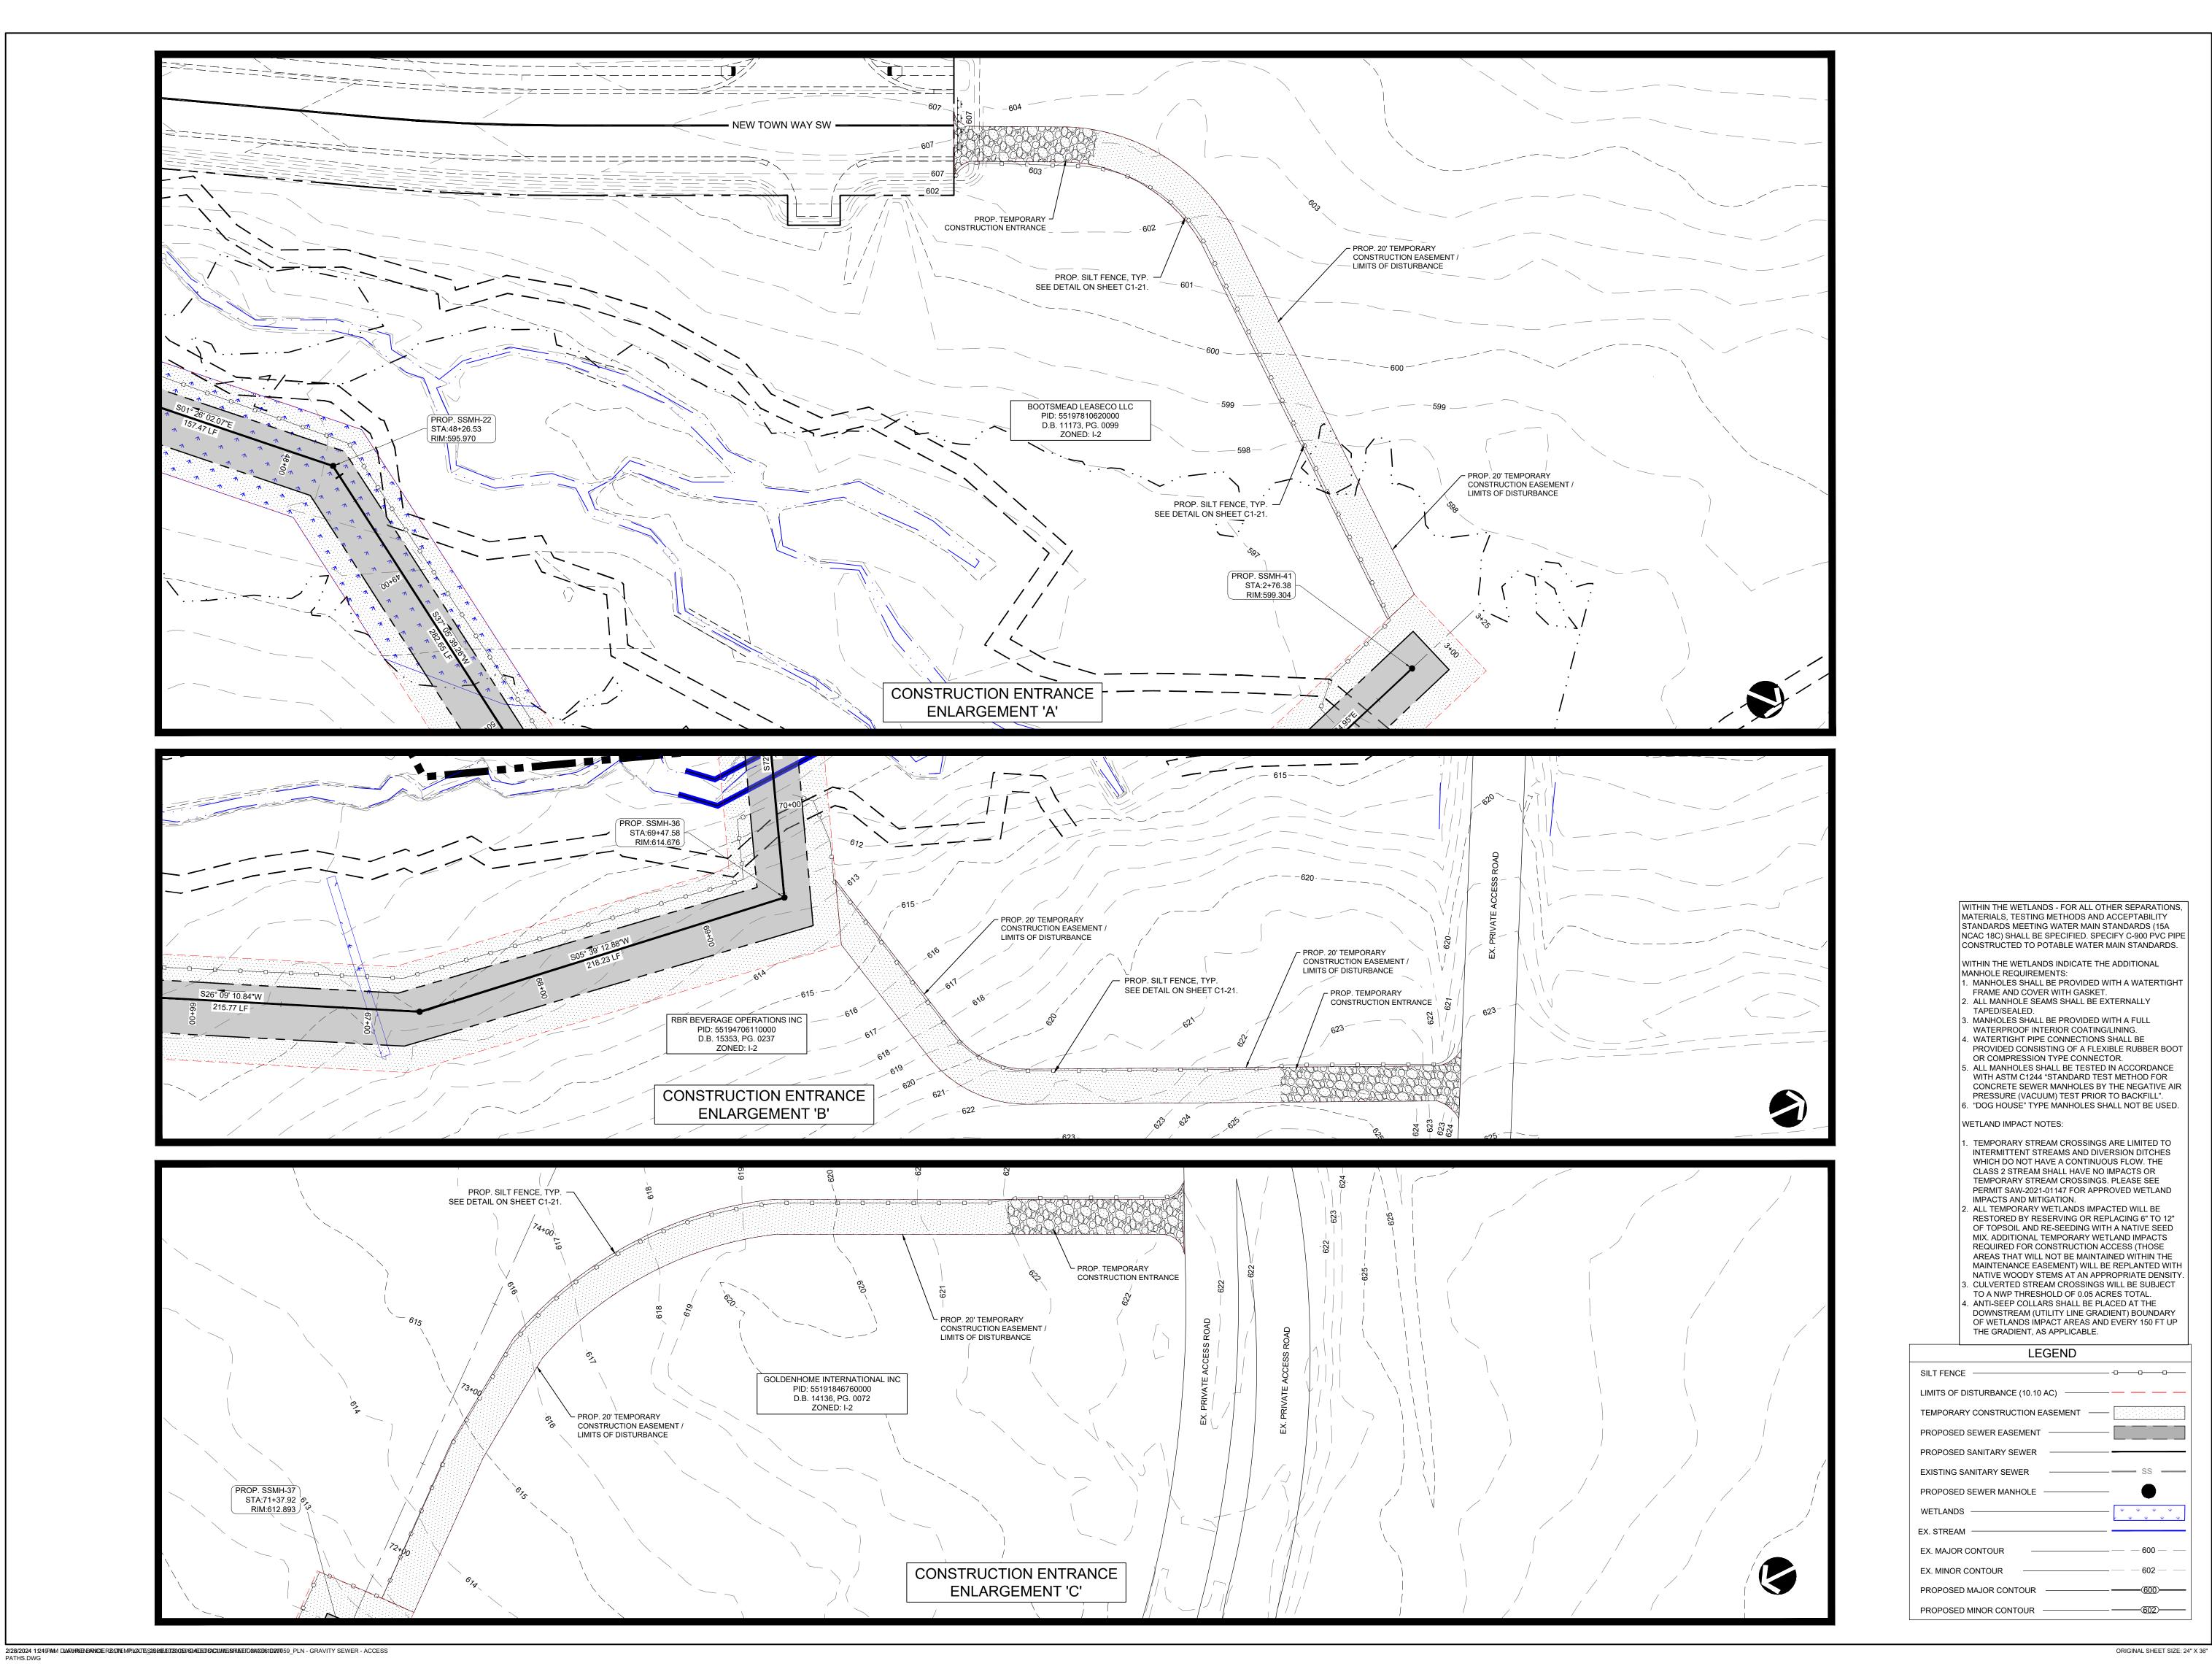ORIGINAL SHEET SIZE: 24" X 36"



LandDesign.

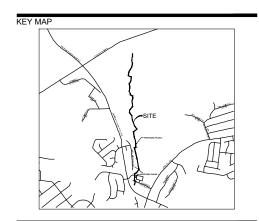223 NORTH GRAHAM STREET CHARLOTTE, NC 28202 704.333.0325 WWW.LANDDESIGN.COM NC ENG. FIRM LICENSE # C-0658





ISSUED FOR PERMITTING

12" PUBLIC SEWER EXTENSION

PHASE 3
CITY OF CONCORD

PO BOX 308

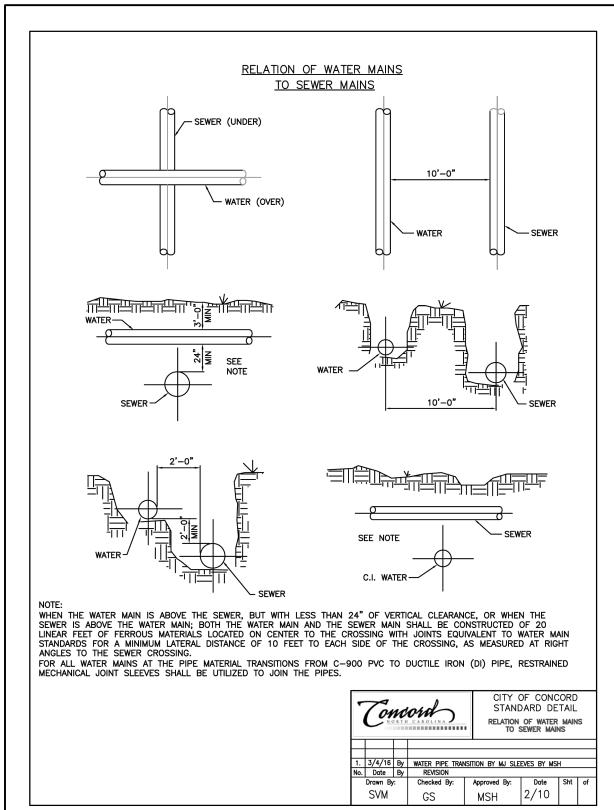
DESIGNED BY: LDI
DRAWN BY: RSK
CHECKED BY: RAK

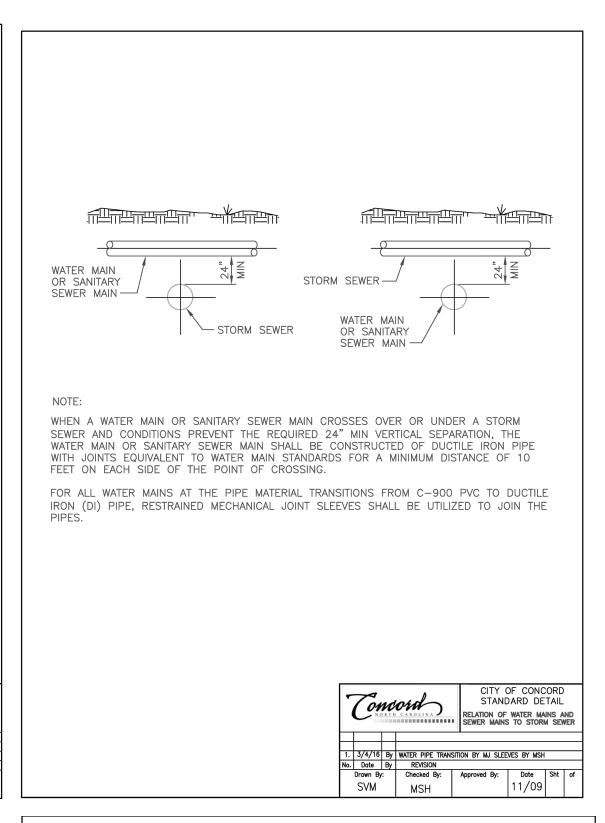
SCALE

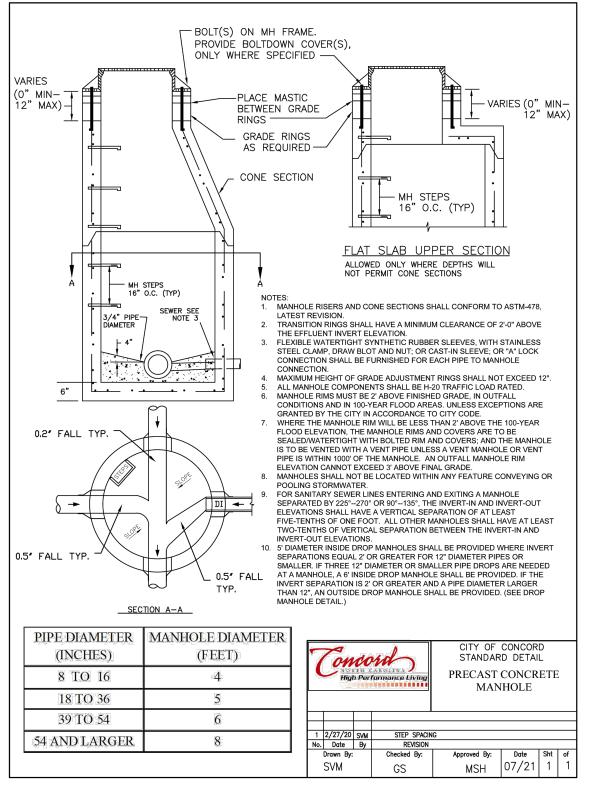
VERT: HORZ: 1"=40'

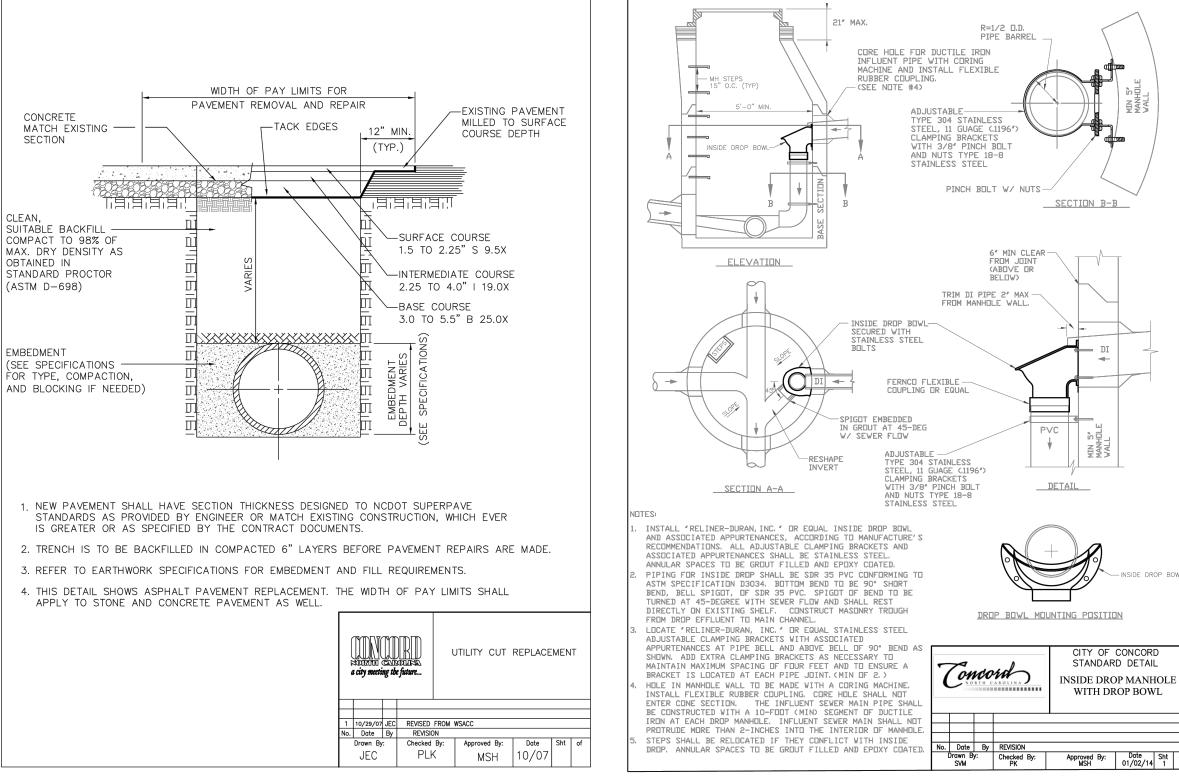
ACCESS PATH AND
CONSTRUCTION ENTRANCE
ENLARGEMENTS

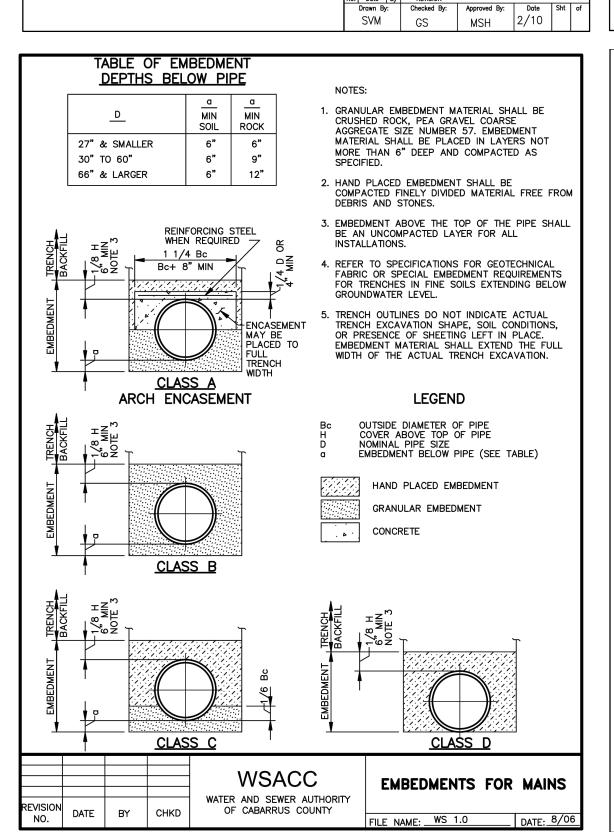
C1-11

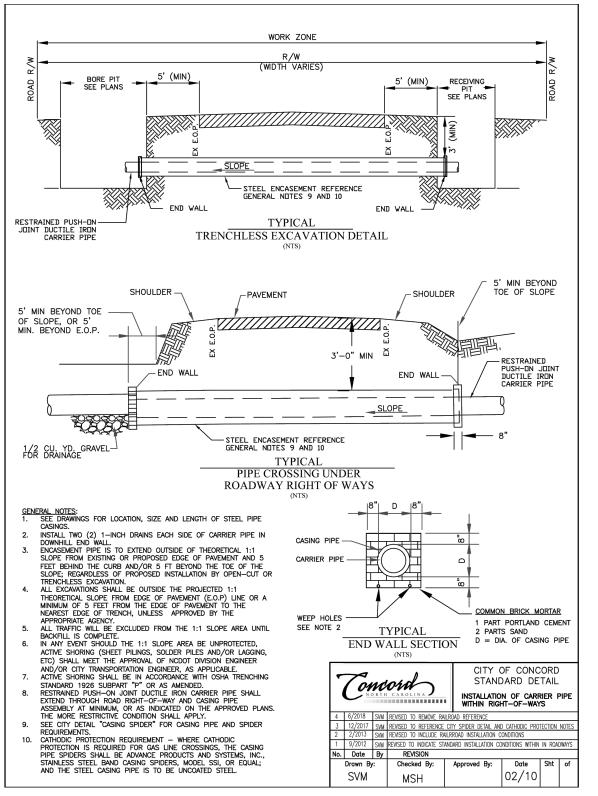


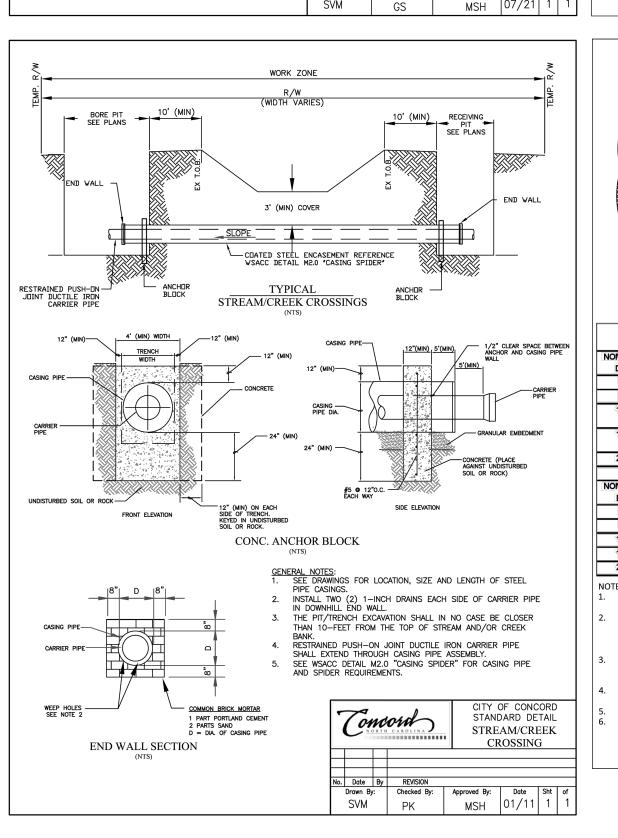


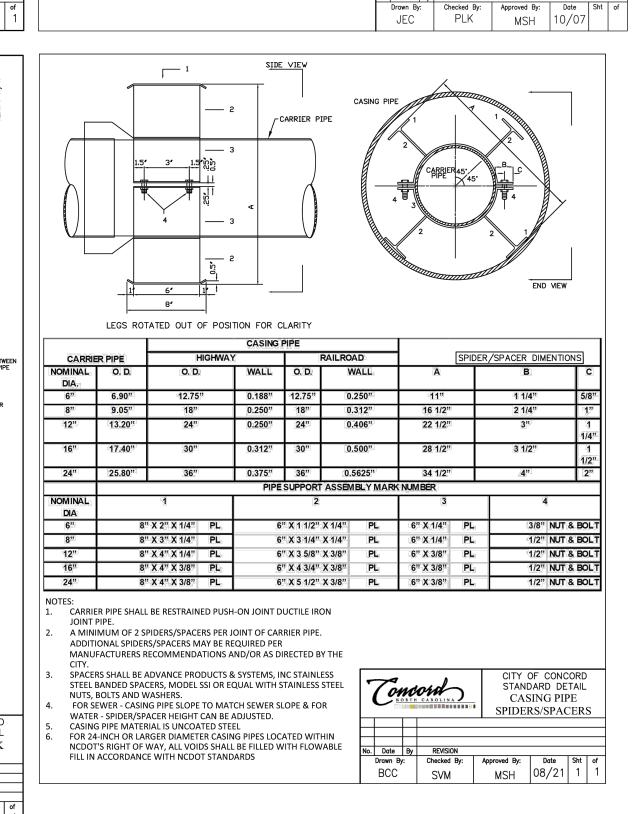


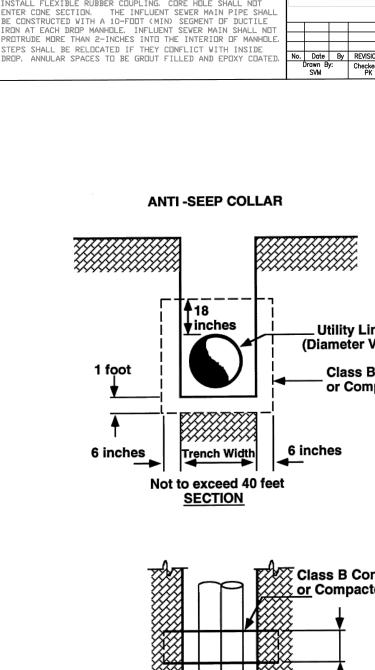


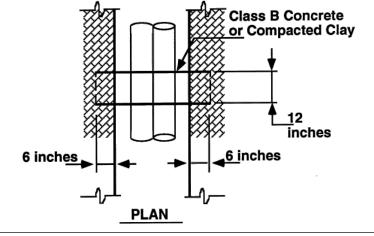














AN ANTI-SEEP COLLAR SHALL BE PLACED AT THE DOWNSTREAM (UTILITY LINE GRADIENT) WETLAND BOUNDARY AND EVERY 150 FEET (45.7 METERS) UP THE GRADIENT UNTIL THE UTILITY EXITS THE WETLAND FOR BURIED UTILITY LINES. ANTI-SEEP COLLARS MAY BE CONSTRUCTED WITH CLASS B CONCRETE, COMPACTED CLAY, PVC PIPE, OR METAL COLLARS. WETLAND CROSSINGS THAT ARE DIRECTIONALLY DRILLED, AND PERPENDICULAR WETLAND CROSSINGS THAT ARE OPEN CUT AND LESS THAN 150 FEET (45.7 METERS) LONG DO NOT REQUIRE ANTI-SEEP COLLARS. THE COMPACTED CLAY SHALL HAVE A SPECIFIC INFILTRATION OF 1 X 10- 5 CM/SEC OR LESS. A SECTION AND PLAN VIEW DIAGRAM IS ATTACHED FOR THE

ANTI-SEEP COLLARS. THE FOLLOWING SPECIFICATIONS SHALL APPLY TO CLASS B CONCRETE: a) MINIMUM CEMENT CONTENT, SACKS PER CUBIC YARD WITH ROUNDED COURSE AGGREGATE 5.0 MINIMUM CEMENT CONTENT, SACKS PER CUBIC YARD WITH ANGULAR COURSE AGGREGATE 5.5 MAXIMUM WATER-CEMENT RATIO GALLONS PER SACK 6.8 SLUMP RANGE 2" TO 4"

MINIMUM STRENGTH - 28 DAY PSI 2,500"

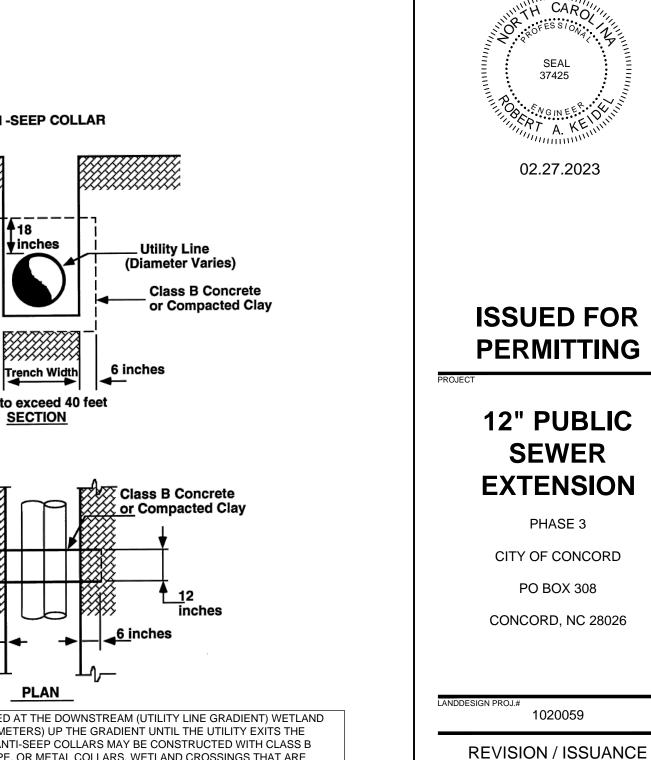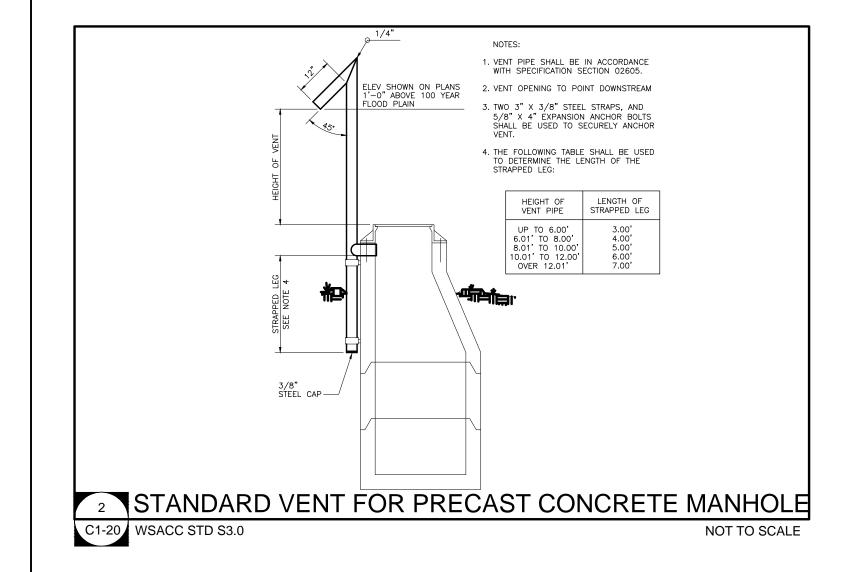1 ANTI-SEEP COLLAR DETAIL C1-20





C1-20

(NOT TO SCALE)

SEWER DETAILS

223 NORTH GRAHAM STREET

CHARLOTTE, NC 28202

704.333.0325 WWW.LANDDESIGN.COM NC ENG. FIRM LICENSE # C-0658

37425

02.27.2023

PHASE 3

PO BOX 308

1020059

DATE

09.01.2022

09.27.2022

03.10.2023

02.27.2024

DESCRIPTION

CITY SUBMITTAL

CITY SUBMITTAL 2

CITY SUBMITTAL 3

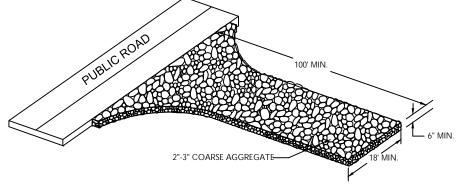
PHASE 3 FOR

CONSTRUCTION

DESIGNED BY: LDI DRAWN BY: RSK CHECKED BY: RAK

VERT: N/A HORZ: NTS

NO.



GENERAL NOTES:

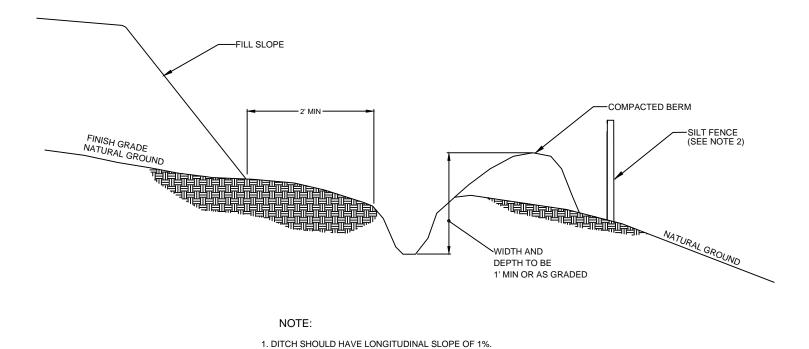
- 1. A STABILIZED PAD OF CRUSHED STONE SHALL BE LOCATED WHERE TRAFFIC WILL BE ENTERING OR LEAVING A CONSTRUCTION SITE TO OR FROM A PUBLIC STREET.
- 2. STONE TO BE 2 3 INCH WASHED STONE.
 3. THE ENTRANCE SHALL BE MAINTAINED IN A CONDITION WHICH WILL PREVENT TRACKING OR FLOWING OF SEDIMENT ONTO PUBLIC STREETS
- OR EXISTING PAVEMENT. THIS MAY REQUIRE PERIODIC TOP DRESSING WITH ADDITIONAL STONE AS CONDITIONS DEMAND AND REPAIR AND/OR CLEANOUT OF ANY MEASURES USED TO TRAP SEDIMENT.
 4. ALL SEDIMENT SPILLED, DROPPED, WASHED OR TRACKED ONTO PUBLIC
- STREETS MUST BE REMOVED IMMEDIATELY. 5. WHEN NECESSARY WHEELS MUST BE CLEANED TO REMOVE SEDIMENT PRIOR TO ENTERING A PUBLIC STREET, WHEN WASHING IS REQUIRED,
- IT SHALL BE DONE ON AN AREA STABILIZED WITH CRUSHED STONE WHICH DRAINS INTO AN APPROVED SEDIMENT BASIN.
 6. FILTER FABRIC SHALL BE PLACED UNDER THE ENTRANCE/EXIT AND

GRAVEL CONSTRUCTION ENTRANCE

NOT TO SCALE

--- 1.33 LB/LF STEEL POST BURIED

OR BURIED OR DRIVEN TO DEPTH OF 18" IN THE GROUND




2. SILT FENCE MAY BE REQUIRED BEHIND BERM

TEMPORARY DIVERSION DITCH C1-21 NCDEQ 6.20

NOT TO SCALE

NOT TO SCALE

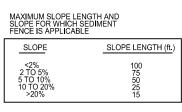COMPACTED FILE



SPECIFICATIONS FOR SEDIMENT FENCE FABRIC

PHYSICAL PROPERTY REQUIREMENTS FILTERING EFFICIENCY 85% (MIN.) TENSILE STRENGTH AT 20% (MAX.) ELONGATION STANDARD STRENGTH 30 LB./LIN. INCH (MIN.) EXTRA STRENGTH-50 LB./LIN.IN (MIN.) SLURRY FLOW RATE 0.3 GAL/SQ. FT/MIN (MIN.)



- 1. DRAINAGE AREA SHALL BE LESS THAN 1/4 ACRE PER 100 FEET OF FENCE.
 2. DEPTH OF WATER BEHIND FENCE SHALL NOT EXCEED 1.5 FEET.
 3. FOR REINFORCEMENT OF FABRIC, USE 14 GAUGE MESH WITH 6" SPACING.
 4. CONSTRUCT FENCE FROM A CONTINUOUS ROLL. JOINTS SHALL OVERLAP BY 4' MINIMUM.

 5. IF WIRE MESH IS USED, FENCE POST SPACING MAY BE 8' MAXIMUM. DO NOT ATTACH FABRIC TO EXISTING TREES.
 INSPECT FENCES WEEKLY AND AFTER RAINFALL EVENTS. REPAIRS SHALL BE MADE IMMEDIATELY.
- 8. REMOVE SEDIMENT DEPOSITS AS NECESSARY TO ENSURE ADEQUATE STORAGE 9. PREFABRICATED SILT FENCE IS NOT ACCEPTABLE.

SEDIMENT FENCE (SILT FENCE) NOT TO SCALE



BE SAME AS STD. #30.09 (19 GAUGE, 1/4" SPACING

3. POSTS SHALL BE NO MORE THAN 4 FEET APART.

2. THE STONE SHALL BE REPLACED PROMPTLY AFTER ANY EVENT THAT HAS CLOGGED OR REMOVED IT.

SEEDING NOTES & SPECIFICATIONS:

GRASS SEED SHALL BE DROUGHT RESISTANT TALL FESCUE AND/OR PERENNIAL RYE UNLESS SPECIFIED OTHERWISE ON THE PLANT LIST. NEW VARIETIES WILL BE CONSIDERED FOR REVIEW. SEED SHALL HAVE A 97% MINIMUM PURITY AND 85% MINIMUM GERMINATION, AND BE FREE OF NOXIOUS WEED SEEDS, AS CERTIFIED BY THE NORTH CAROLINA CO-OP IMPROVEMENT ASSOCIATION OR ITS

APPROVED EQUIVALENT BY THE CONSULTANT.

SEEDING SPECIFICATIONS

SEASON	TYPE OF SEEED	DATE	RATE
FALL	TALL FESCUE	SEP 1 - NOV 15	7 LBS/1,000 SF
	PERENNIAL RYE		5 LBS/1,000 SF
WINTER	PERENNIAL RYE	NOV 15 - MARCH 1	7 LBS/1,000 SF

BLEND OF TWO TURF 5 LBS/1,000 SF SPRING / SUMMER TYPE TALL FESCUE. WITH RYE GRAIN COVER CROP

Major Elements of DWQ Construction General Permit

Ground Stabilization	on*		The major change in the Permit from the previous one is the shorter times to apply ground stabilization such as mulch, wheat straw, or grasses. The NC laws and rules relating to the Sediment Act require,
Site Area Description	Stabilization Time Frame	Stabilization Time Frame Exceptions	in most places, ground stabilization within 21 days. Based on the new EPA requirements and 9-months' work with a permit advisory group, CTAG the Division and EPA-developed permit, now contains
Perimeter dikes, swales, ditches and slopes	7 days	None	requirements for ground cover within 14, and in some places, 7 days.
High Quality Water (HQW) Zones	7 days	None	Building Wastes Handling No paint or liquid wastes in stream or storm drains
Slopes steeper than 3:1	7 days	If slopes are 10° or less in length and are not steeper than 2:1, 14 days are allowed.	Dedicated areas for demolition, construction and other wastes must be located 50' from storm drains and streams unless no reasonable alternatives available.
Slopes 3:1 or flatter	14 days	7-days for slopes greater than 50 feet in length	 Earthen-material stockpiles must be located 50' from storm drains and streams unless no reasonable alternatives available.
All other areas with slopes flatter	14 days	None (except for perimeters and	 Concrete materials must be controlled to avoid contact with surface waters, wetlands, or buffers.
than 4:1 extensions of time may	he seemed by the	HQW Zones)	3) Discharges to Federally-listed Waters
ed on weather or other	site-specific conditi	ions that make compliance	Requirements are the same as in previous permit.
racticable." (Section II.	B(2)(b))		 The permit allows reduction from the 20 acre minimum if the Director of DWQ determines that other BMPs provide equivalent protection.

STABILIZATION TIMEFRAMES (Effective Aug. 3, 2011)				
SITE AREA DESCRIPTION	STABILIZATION	TIMEFRAME EXCEPTIONS		
Perimeter dikes, swales, ditches, slopes	7 days	None		
High Quality Water (HQW) Zones	7 days	None		
Slopes steeper than 3:1	7 days	If slopes are 10° or less in length and are not steeper than 2:1, 14 days are allowed.		
Slopes 3:1 or flatter	14 days	7 days for slopes greater than 50' in length.		
All other areas with slopes flatter than 4:1	14 days	None, except for perimeters and HQW Zones		

MAINTENANCE SCHEDULE:

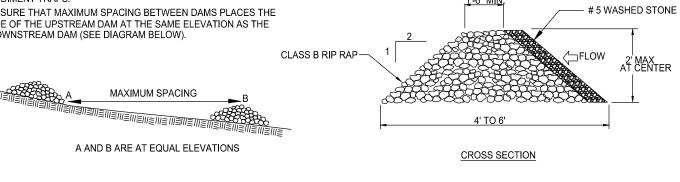
. SEDIMENT FILTER OUTLET AND HARDWARE CLOTH SHALL BE 16 INCHES HIGH BUT NO TALLER THAN 18 INCHES.

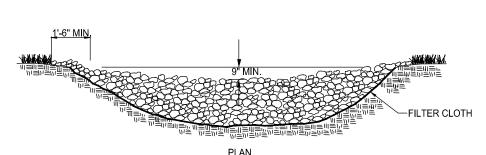
4. SITE OUTLETS AT ANY POINT SMALL CONCENTRATED FLOWS ARE ANTICIPATED AND AT THE DIRECTION OF THE INSPECTOR.

- 1). ALL EROSION AND SEDIMENT CONTROL PRACTICES SHALL BE CHECKED FOR STABILITY AND OPERATION FOLLOWING EVERY STORM EVENT, BUT IN NO CASE LESS THAN ONCE EVERY WEEK. ANY REPAIRS OR CLEANING NECESSARY TO MAINTAIN EROSION AND SEDIMENT CONTROL PRACTICES SHALL BE COMPLETED IMMEDIATELY.
- 2). ALL SEEDED AREAS SHALL BE REFERTILIZED. RESEEDED AS NECESSARY, AND MULCHED ACCORDING TO THE SEEDING SCHEDULE.
- 3.) MONITORING OF EROSION CONTROL AND SEDIMENTATION CONTROL MEASURES IS REQUIRED AT LEAST ONCE PER WEEK OR AFTER EVERY HALF INCH OF RAINFALL.
- EFFECTIVE OCTOBER 1, 2010, PERSONS RESPONSIBLE FOR LAND DISTURBING ACTIVITIES MUST INSPECT A PROJECT AFTER EACH PHASE OF THE PROJECT TO MAKE SURE THAT THE APPROVED EROSION EROSION CONTROL AND SEDIMENTATION CONTROL PLAN IS BEING FOLLOWED. SELF-INSPECTION REPORTS ARE REQUIRED. A SAMPLE SELF-INSPECTION REPORT. AS WELL AS DETAILS OF THE SELF-INSPECTION PROGRAM, CAN BE FOUND ON THE LAND QUALITY WEB SITE: HTTP://WWW.DLR.ENR.STATE.NC.US/PAGES/SEDIMENTAION_NEW.HTML
- NOT EVERY PROJECT WILL HAVE ALL POSSIBLE PHASES, BUT A LIST OF PHASES INCLUDE: (1) INSTALLATION OF PERIMETER EROSION AND SEDIMENT CONTROL MEASURES (2) INSTALLATION OF SEDIMENT TRAPS/BASINS. (3) CLEARING AND GRUBBING EXISTING GROUND COVER.

GENERAL NOTES:

- 1. RIPRAP SIZE TO BE DESIGNED BY ENGINEER.
- 2. CHECK DAMS MAY BE USED IN SLOPING DITCHES
- OR CHANNELS TO SLOW VELOCITY OR TO CREATE SEDIMENT TRAPS. ENSURE THAT MAXIMUM SPACING BETWEEN DAMS PLACES THE TOE OF THE UPSTREAM DAM AT THE SAME ELEVATION AS THE DOWNSTREAM DAM (SEE DIAGRAM BELOW).





TEMPORARY ROCK CHECK DAM

NOT TO SCALE

GENERAL NOTES:

1. ALL EROSION CONTROL MEASURES SHALL BE CONSTRUCTED IN ACCORDANCE WITH THE CURRENT N.C. EROSION AND SEDIMENT CONTROL PLANNING AND DESIGN MANUAL (WEBSITE:

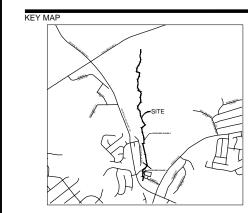
EROSION CONTROL NOTES:

- HTTPS://DEQ.NC.GOV) 2. ALL "STD." NUMBERS REFER TO THE NORTH CAROLINA DEPARTMENT OF ENVIRONMENTAL QUALITY, UNLESS OTHERWISE NOTED.
- 3. ON-SITE BURIAL PITS REQUIRE AN ON-SITE DEMOLITION LANDFILL PERMIT FROM THE ZONING ADMINISTRATOR. 4. ANY GRADING BEYOND THE DENUDED LIMITS SHOWN ON THE PLAN IS
- AN VIOLATION OF THE STATE'S EROSION CONTROL STATUTES AND IS SUBJECT TO A FINE. GRADING MORE THAN ONE ACRE WITHOUT AN APPROVED EROSION CONTROL PLAN IS A VIOLATION OF THE STATE'S EROSION CONTROL
- STATUTES AND IS SUBJECT TO A FINE. 6. STABILIZATION IS THE BEST FORM OF EROSION CONTROL. TEMPORARY SEEDING IS NECESSARY TO ACHIEVE EROSION CONTROL ON LARGE DENUDED AREAS AND ESPECIALLY WHEN SPECIFICALLY REQUIRED AS PART OF THE CONSTRUCTION SEQUENCE SHOWN ON
- THE PLAN. 7. GROUND STABILIZATION MUST OCCUR WITHIN 7 DAYS OF COMPLETION OF GRADING ON PERIMETER AREAS AND ON SLOPES GREATER THAN 3:1. GROUND STABILIZATION MUST OCCUR WITHIN 14 DAYS OF
- COMPLETION OF GRADING ON ALL OTHER AREAS OF THE PROJECT. (REFER TO NCDEQ STABILIZATION TIMEFRAME) 8. ANY AREAS DISTURBED WHERE SEDIMENT CONTROL IS NOT FEASIBLE
- OR EROSION WILL CAUSE SEDIMENT TO ENTER WATER COURSE (CREEK BANKS, CREEK BED, DISTURBED CHANNELS) MUST BE STABILIZED THE SAME DAY THE AREA IS DISTURBED.
- 9. ANY OFFSITE BORROW PITS, BURY PITS OR STOCKPILE AREAS MUST HAVE AN APPROVED EROSION AND SEDIMENTATION CONTROL PERMIT. 10. FAILURE TO SCHEDULE AN ON-SITE MEETING WITH THE STATE'S EROSION CONTROL COORDINATOR 48 HOURS PRIOR TO ANY LAND DISTURBING ACTIVITY IS A VIOLATION OF STATE STATUTES AND IS
- 11. ADDITIONAL MEASURES TO CONTROL EROSION AND SEDIMENT MAY BE REQUIRED BY A REPRESENTATIVE OF THE CITY OF CONCORD
- ENGINEERING DEPARTMENT OR NCDEQ. 12. TOTAL PROJECT DISTURBED AREA = 101.89 AC 13. SLOPES SHALL BE GRADED NO STEEPER THAN 2:1, UNLESS DIRECTED
- BY THE ENGINEER. 14. SAND OR SCREENING SHOULD BE REQUIRED BENEATH EXCAVATED MATERIAL THAT IS STOCKPILED ON STREETS OR PAVED SURFACES.

- 1. ALL PROPERTY AFFECTED BY THIS WORK SHALL BE RESTORED TO A CONDITION EQUAL TO OR BETTER THAN THE EXISTING UNLESS OTHERWISE SPECIFICALLY EXEMPTED BY THESE PLANS. 2. THE CONTRACTOR IS CAUTIONED THAT THE LOCATION AND/OR
- ELEVATION OF EXISTING UTILITIES AS SHOWN ON THESE PLANS ARE BASED ON RECORDS TAKEN BY AN EXISTING ALTA / ACSM LAND TITLE SURVEY BY WK DICKSON IN SEPTEMBER OF 2009. THE INFORMATION IS NOT TO BE RELIED ON AS BEING EXACT OR COMPLETE. THE LOCATION OF EXISTING UTILITIES MUST BE VERIFIED IN THE FIELD BY THE CONTRACTOR PRIOR TO CONSTRUCTION.
- 3. THE CONTRACTOR SHALL IMMEDIATELY REPORT TO THE OWNER AND ENGINEER ANY DISCREPANCIES FOUND BETWEEN ACTUAL FIELD CONDITIONS AND CONSTRUCTION DOCUMENTS AND SHALL WAIT FOR INSTRUCTIONS PRIOR TO PROCEEDING. 4. PRIOR TO BEGINNING CONSTRUCTION THE CONTRACTOR IS RESPONSIBLE TO VERIFY THAT ALL REQUIRED PERMITS AND APPROVALS HAVE BEEN OBTAINED FROM ALL REGULATORY
- AUTHORITIES AND SHALL BE THOROUGHLY FAMILIAR WITH CONDITIONS OF SAID PERMITS AND INSPECTION REQUIREMENTS. 5. THE GENERAL CONTRACTOR SHALL CONTACT ALL OWNERS OF EASEMENTS, UTILITIES AND RIGHT-OF-WAYS, PUBLIC OR PRIVATE PRIOR TO WORKING IN THESE AREAS.
- 6. THE CONTRACTOR SHALL BE RESPONSIBLE FOR DAMAGE TO ANY EXISTING ITEM AND/OR MATERIAL INSIDE OR OUTSIDE THE CONSTRUCTION LIMITS.
- 7. CONTRACTOR SHALL MAINTAIN THE SITE IN A MANNER SO THAT WORKMEN AND PUBLIC ARE PROTECTED FROM INJURY. 8. LANDDESIGN SHALL NOT BE IN CONTROL OR CHARGE OF, AND
- SHALL NOT BE RESPONSIBLE FOR ACTUAL CONSTRUCTION MEANS, METHODS, TECHNIQUES, PROCEDURES, OR SAFETY PRECAUTIONS IN CONNECTION WITH THE WORK, OR FOR THE ACTS OR OMISSIONS OF CONTRACTORS OR ANY OTHER PERSONS NOT UNDER THE EMPLOYMENT OF LANDDESIGN.

1. NO STREAM/WETLAND IMPACTS MAY BE PERFORMED UNTIL ALL APPLICABLE PERMITS HAVE BEEN RECEIVED BY THE U.S. ARMY CORPS OF ENGINEERS AND NCDEQ.


2. ADEQUATE TEMPORARY SEDIMENT CONTROLS SHALL BE PROVIDED AT THE END OF EACH WORK DAY AT ALL STREAM CROSSINGS UNTIL ADEQUATE PERMANENT GROUND COVER IS PROVIDED. 3. STAGING AREAS AND STOCKPILES MUST BE LOCATED OUTSIDE OF THE STREAM BUFFER ZONE WHENEVER POSSIBLE. WORK WITHIN THE STREAM BUFFER SHOULD BE SEQUENCED TO MINIMIZE THE LENGTH OF TIME THAT DISTURBED AREAS ARE TO EXPOSED. ALL MATERIALS MUST BE ON HAND BEFORE WORK IS COMMENCED. STREAM BANK STABILIZATION, WHICH INCLUDES THE AREA FROM THE EDGE OF WATER TO THE TOP OF BANK, SHOULD BE PHASED SO THAT EACH DAY'S WORK IS COMPLETED AND ADEQUATELY STABILIZED AT THE END OF EACH WORK



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NC ENG. FIRM LICENSE # C-0658



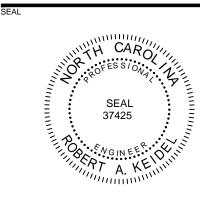ISSUED FOR PERMITTING

12" PUBLIC **SEWER EXTENSION**

PHASE 3

CITY OF CONCORD

PO BOX 308

CONCORD, NC 28026

1020059 REVISION / ISSUANCE NO. DESCRIPTION DATE CITY SUBMITTAL 09.01.2022 CITY SUBMITTAL 2 09.27.2022 CITY SUBMITTAL 3 03.10.2023 PHASE 3 FOR 02.27.2024 CONSTRUCTION

> DESIGNED BY: LDI DRAWN BY: RSK CHECKED BY: RAK

HORZ: NTS

EROSION CONTROL DETAILS

GROUND STABILIZATION AND MATERIALS HANDLING PRACTICES FOR COMPLIANCE WITH THE NCG01 CONSTRUCTION GENERAL PERMIT

Implementing the details and specifications on this plan sheet will result in the construction activity being considered compliant with the Ground Stabilization and Materials Handling sections of the NCG01 Construction General Permit (Sections E and F, respectively). The permittee shall comply with the Erosion and Sediment Control plan approved by the delegated authority having jurisdiction. All details and specifications shown on this sheet may not apply depending on site conditions and the delegated authority having jurisdiction.

SECTION E: GROUND STABILIZATION

	Required Ground Stabilization Timeframes				
Si	te Area Description	Stabilize within this many calendar days after ceasing land disturbance	Timeframe variations		
(a)	Perimeter dikes, swales, ditches, and perimeter slopes	7	None		
(b)	High Quality Water (HQW) Zones	7	None		
(c)	Slopes steeper than 3:1	7	If slopes are 10' or less in length and are not steeper than 2:1, 14 days are allowed		
(d)	Slopes 3:1 to 4:1	14	-7 days for slopes greater than 50' in length and with slopes steeper than 4:1 -7 days for perimeter dikes, swales, ditches, perimeter slopes and HQW Zones -10 days for Falls Lake Watershed		
(e)	Areas with slopes flatter than 4:1	14	-7 days for perimeter dikes, swales, ditches, perimeter slopes and HQW Zones -10 days for Falls Lake Watershed unless there is zero slope		

Note: After the permanent cessation of construction activities, any areas with temporary ground stabilization shall be converted to permanent ground stabilization as soon as practicable but in no case longer than 90 calendar days after the last land disturbing activity. Temporary ground stabilization shall be maintained in a manner to render the surface stable against accelerated erosion until permanent ground stabilization is achieved.

GROUND STABILIZATION SPECIFICATION

Stabilize the ground sufficiently so that rain will not dislodge the soil. Use one of the techniques in the table below:

Temporary Stabilization	Permanent Stabilization	
 Temporary grass seed covered with straw or other mulches and tackifiers Hydroseeding Rolled erosion control products with or without temporary grass seed Appropriately applied straw or other mulch Plastic sheeting 	 Permanent grass seed covered with straw or other mulches and tackifiers Geotextile fabrics such as permanent soil reinforcement matting Hydroseeding Shrubs or other permanent plantings covered with mulch Uniform and evenly distributed ground cover 	
	 sufficient to restrain erosion Structural methods such as concrete, asphalt or 	
	retaining walls	
vt	 Rolled erosion control products with grass seed 	

POLYACRYLAMIDES (PAMS) AND FLOCCULANTS

- Select flocculants that are appropriate for the soils being exposed during construction, selecting from the NC DWR List of Approved PAMS/Flocculants.
- Apply flocculants at or before the inlets to Erosion and Sediment Control Measures.
- Apply flocculants at the concentrations specified in the NC DWR List of Approved PAMS/Flocculants and in accordance with the manufacturer's instructions.
- Provide ponding area for containment of treated Stormwater before discharging
- Store flocculants in leak-proof containers that are kept under storm-resistant cover or surrounded by secondary containment structures.

EQUIPMENT AND VEHICLE MAINTENANCE

- 1. Maintain vehicles and equipment to prevent discharge of fluids.
- 2. Provide drip pans under any stored equipment.
- 3. Identify leaks and repair as soon as feasible, or remove leaking equipment from the project.
- 4. Collect all spent fluids, store in separate containers and properly dispose as hazardous waste (recycle when possible).
- 5. Remove leaking vehicles and construction equipment from service until the problem has been corrected.
- 6. Bring used fuels, lubricants, coolants, hydraulic fluids and other petroleum products to a recycling or disposal center that handles these materials.

LITTER, BUILDING MATERIAL AND LAND CLEARING WASTE

- Never bury or burn waste. Place litter and debris in approved waste containers.
- 2. Provide a sufficient number and size of waste containers (e.g dumpster, trash receptacle) on site to contain construction and domestic wastes.
- 3. Locate waste containers at least 50 feet away from storm drain inlets and surface waters unless no other alternatives are reasonably available.
- 4. Locate waste containers on areas that do not receive substantial amounts of runoff from upland areas and does not drain directly to a storm drain, stream or wetland.
- 5. Cover waste containers at the end of each workday and before storm events or provide secondary containment. Repair or replace damaged waste containers.
- 6. Anchor all lightweight items in waste containers during times of high winds.
- 7. Empty waste containers as needed to prevent overflow. Clean up immediately if containers overflow.
- 8. Dispose waste off-site at an approved disposal facility.
- 9. On business days, clean up and dispose of waste in designated waste containers.

PAINT AND OTHER LIQUID WASTE

- 1. Do not dump paint and other liquid waste into storm drains, streams or wetlands.
- 2. Locate paint washouts at least 50 feet away from storm drain inlets and surface waters unless no other alternatives are reasonably available.
- Contain liquid wastes in a controlled area.
- Containment must be labeled, sized and placed appropriately for the needs of site.
- Prevent the discharge of soaps, solvents, detergents and other liquid wastes from construction sites.

PORTABLE TOILETS

- Install portable toilets on level ground, at least 50 feet away from storm drains, streams or wetlands unless there is no alternative reasonably available. If 50 foot offset is not attainable, provide relocation of portable toilet behind silt fence or place on a gravel pad and surround with sand bags.
- Provide staking or anchoring of portable toilets during periods of high winds or in high foot traffic areas.
- Monitor portable toilets for leaking and properly dispose of any leaked material. Utilize a licensed sanitary waste hauler to remove leaking portable toilets and replace with properly operating unit.

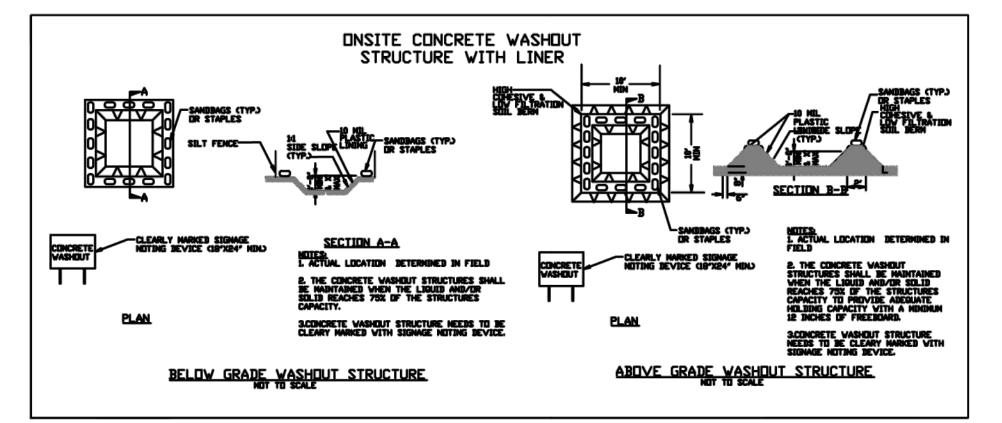
EARTHEN STOCKPILE MANAGEMENT

- Show stockpile locations on plans. Locate earthen-material stockpile areas at least 50 feet away from storm drain inlets, sediment basins, perimeter sediment controls and surface waters unless it can be shown no other alternatives are reasonably available.
- Protect stockpile with silt fence installed along toe of slope with a minimum offset of five feet from the toe of stockpile.
- Provide stable stone access point when feasible.

NCG01 GROUND STABILIZATION AND MATERIALS HANDLING

Stabilize stockpile within the timeframes provided on this sheet and in accordance with the approved plan and any additional requirements. Soil stabilization is defined as vegetative, physical or chemical coverage techniques that will restrain accelerated erosion on disturbed soils for temporary or permanent control needs.





CONCRETE WASHOUTS

- Do not discharge concrete or cement slurry from the site.
- Dispose of, or recycle settled, hardened concrete residue in accordance with local and state solid waste regulations and at an approved facility.
- 3. Manage washout from mortar mixers in accordance with the above item and in addition place the mixer and associated materials on impervious barrier and within lot perimeter silt fence.
- Install temporary concrete washouts per local requirements, where applicable. If an alternate method or product is to be used, contact your approval authority for review and approval. If local standard details are not available, use one of the two types of temporary concrete washouts provided on this detail.
- Do not use concrete washouts for dewatering or storing defective curb or sidewalk sections. Stormwater accumulated within the washout may not be pumped into or discharged to the storm drain system or receiving surface waters. Liquid waste must be pumped out and removed from project.
- Locate washouts at least 50 feet from storm drain inlets and surface waters unless it can be shown that no other alternatives are reasonably available. At a minimum, install protection of storm drain inlet(s) closest to the washout which could receive spills or overflow.
- Locate washouts in an easily accessible area, on level ground and install a stone entrance pad in front of the washout. Additional controls may be required by the approving authority.
- Install at least one sign directing concrete trucks to the washout within the project limits. Post signage on the washout itself to identify this location.
- Remove leavings from the washout when at approximately 75% capacity to limit overflow events. Replace the tarp, sand bags or other temporary structural components when no longer functional. When utilizing alternative or proprietary products, follow manufacturer's instructions.
- 10. At the completion of the concrete work, remove remaining leavings and dispose of in an approved disposal facility. Fill pit, if applicable, and stabilize any disturbance caused by removal of washout.

HERBICIDES, PESTICIDES AND RODENTICIDES


- 1. Store and apply herbicides, pesticides and rodenticides in accordance with label restrictions.
- Store herbicides, pesticides and rodenticides in their original containers with the label, which lists directions for use, ingredients and first aid steps in case of accidental poisoning.
- Do not store herbicides, pesticides and rodenticides in areas where flooding is possible or where they may spill or leak into wells, stormwater drains, ground water or surface water. If a spill occurs, clean area immediately.
- Do not stockpile these materials onsite.


HAZARDOUS AND TOXIC WASTE

- Create designated hazardous waste collection areas on-site.
- Place hazardous waste containers under cover or in secondary containment.
- Do not store hazardous chemicals, drums or bagged materials directly on the ground.

EFFECTIVE: 04/01/19

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ISSUED FOR PERMITTING

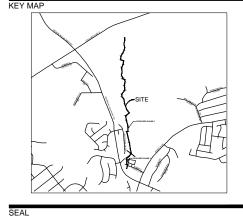12" PUBLIC **SEWER EXTENSION**

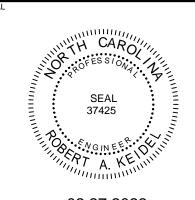PHASE 3 CITY OF CONCORD

PO BOX 308

CONCORD, NC 28026

1020059

REVISION / ISSUANCE DESCRIPTION CITY SUBMITTAL 2 CITY SUBMITTAL 3 03.10.2023 CONSTRUCTION

DESIGNED BY: LDI DRAWN BY: RSK CHECKED BY: RAK

HORZ: NTS

EROSION CONTROL DETAILS

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23/2024 1:42 PM LAUREN ANDERSON P:\CLT_2020\1020059\CAD\DOCUMENTATION\CD\1020059_DTL-SEWER - PH 2.DW

PART III SELF-INSPECTION, RECORDKEEPING AND REPORTING

SECTION A: SELF-INSPECTION

Self-inspections are required during normal business hours in accordance with the table below. When adverse weather or site conditions would cause the safety of the inspection personnel to be in jeopardy, the inspection may be delayed until the next business day on which it is safe to perform the inspection. In addition, when a storm event of equal to or greater than 1.0 inch occurs outside of normal business hours, the self-inspection shall be performed upon the commencement of the next business day. Any time when inspections were delayed shall be noted in the Inspection Record.

Inspect	Frequency (during normal business hours)	Inspection records must include:	
(1) Rain gauge maintained in good working order	Daily	Daily rainfall amounts. If no daily rain gauge observations are made during weekend holiday periods, and no individual-day rainfall information available, record the cumulative rain measurement for those u attended days (and this will determine if a site inspection needed). Days on which no rainfall occurred shall be recorded "zero." The permittee may use another rain-monitoring device approved by the Division	
(2) E&SC (1) Measures	At least once per 7 calendar days and within 24 hours of a rain event > 1.0 inch in 24 hours	 Identification of the measures inspected, Date and time of the inspection, Name of the person performing the inspection, Indication of whether the measures were operating properly, Description of maintenance needs for the measure, Description, evidence, and date of corrective actions taken. 	
(3) Stormwater discharge outfalls (SDOs)	At least once per 7 calendar days and within 24 hours of a rain event > 1.0 inch in 24 hours	 Identification of the discharge outfalls inspected, Date and time of the inspection, Name of the person performing the inspection, Evidence of indicators of stormwater pollution such as oil sheen, floating or suspended solids or discoloration, Indication of visible sediment leaving the site, Description, evidence, and date of corrective actions taken. 	
(4) Perimeter of site	At least once per 7 calendar days and within 24 hours of a rain event ≥ 1.0 inch in 24 hours	If visible sedimentation is found outside site limits, then a record of the following shall be made: 1. Actions taken to clean up or stabilize the sediment that has left the site limits, 2. Description, evidence, and date of corrective actions taken, and 3. An explanation as to the actions taken to control future releases.	
(5) Streams or wetlands onsite or offsite (where accessible)	At least once per 7 calendar days and within 24 hours of a rain event > 1.0 inch in 24 hours	If the stream or wetland has increased visible sedimentation or a stream has visible increased turbidity from the construction activity, then a record of the following shall be made: 1. Description, evidence and date of corrective actions taken, and 2. Records of the required reports to the appropriate Division Regional Office per Part III, Section C, Item (2)(a) of this permit of this permit.	
(6) Ground stabilization measures	After each phase of grading	1. The phase of grading (installation of perimeter E&SC measures, clearing and grubbing, installation of storm drainage facilities, completion of all land-disturbing activity, construction or redevelopment, permanent ground cover). 2. Documentation that the required ground stabilization measures have been provided within the required timeframe or an assurance that they will be provided as soon as possible.	

NOTE: The rain inspection resets the required 7 calendar day inspection requirement.

PART III SELF-INSPECTION, RECORDKEEPING AND REPORTING

SECTION B: RECORDKEEPING

1. E&SC Plan Documentation

The approved E&SC plan as well as any approved deviation shall be kept on the site. The approved E&SC plan must be kept up-to-date throughout the coverage under this permit. The following items pertaining to the E&SC plan shall be documented in the manner described:

Item to Document	Documentation Requirements	
(a) Each E&SC Measure has been installed and does not significantly deviate from the locations, dimensions and relative elevations shown on the approved E&SC Plan.	Initial and date each E&SC Measure on a copy of the approved E&SC Plan or complete, date and sign an inspection report that lists each E&SC Measure shown on the approved E&SC Plan. This documentation is required upon the initial installation of the E&SC Measures or if the E&SC Measures are modified after initial installation.	
(b) A phase of grading has been completed.	Initial and date a copy of the approved E&SC Plan or complete, date and sign an inspection report to indicate completion of the construction phase.	
(c) Ground cover is located and installed in accordance with the approved E&SC Plan.	Initial and date a copy of the approved E&SC Plan or complete, date and sign an inspection report to indicate compliance with approved ground cover specifications.	
(d) The maintenance and repair requirements for all E&SC Measures have been performed.	Complete, date and sign an inspection report.	
(e) Corrective actions have been taken to E&SC Measures.	Initial and date a copy of the approved E&SC Plan or complete, date and sign an inspection report to indicate the completion of the corrective action.	

2. Additional Documentation

In addition to the E&SC Plan documents above, the following items shall be kept on the

and available for agency inspectors at all times during normal business hours, unless the Division provides a site-specific exemption based on unique site conditions that make this requirement not practical:

- This general permit as well as the certificate of coverage, after it is received.
- Records of inspections made during the previous 30 days. The permittee shall record the required observations on the Inspection Record Form provided by the Division or a similar inspection form that includes all the required elements. Use of electronically-available records in lieu of the required paper copies will be allowed if shown to provide equal access and utility as the hard-copy records.
- All data used to complete the Notice of Intent and older inspection records shall be maintained for a period of three years after project completion and made available upon request. [40 CFR 122.41]

PART III SELF-INSPECTION, RECORDKEEPING AND REPORTING

SECTION C: REPORTING

1. Occurrences that must be reported

Permittees shall report the following occurrences:

- (a) Visible sediment deposition in a stream or wetland.
- (b) Oil spills if:
 - They are 25 gallons or more,
 - They are less than 25 gallons but cannot be cleaned up within 24 hours,
 - They cause sheen on surface waters (regardless of volume), or
 - They are within 100 feet of surface waters (regardless of volume).
- (a) Releases of hazardous substances in excess of reportable quantities under Section 311 of the Clean Water Act (Ref: 40 CFR 110.3 and 40 CFR 117.3) or Section 102 of CERCLA (Ref: 40 CFR 302.4) or G.S. 143-215.85.
- (b) Anticipated bypasses and unanticipated bypasses.
- (c) Noncompliance with the conditions of this permit that may endanger health or the environment.

2. Reporting Timeframes and Other Requirements

After a permittee becomes aware of an occurrence that must be reported, he shall contact the appropriate Division regional office within the timeframes and in accordance with the other requirements listed below. Occurrences outside normal business hours may also be reported to the Division's Emergency Response personnel at (800) 662-7956, (800) 858-0368 or (919) 733-3300.


Occurrence	Reporting Timeframes (After Discovery) and Other Requirements
(a) Visible sediment deposition in a stream or wetland	 Within 24 hours, an oral or electronic notification. Within 7 calendar days, a report that contains a description of the sediment and actions taken to address the cause of the deposition. Division staff may waive the requirement for a written report on a case-by-case basis. If the stream is named on the NC 303(d) list as impaired for sediment-related causes, the permittee may be required to perform additional monitoring, inspections or apply more stringent practices if staff determine that additional requirements are needed to assure compliance with the federal or state impaired-waters conditions.
(b) Oil spills and release of hazardous substances per Item 1(b)-(c) above	Within 24 hours, an oral or electronic notification. The notification shall include information about the date, time, nature, volume and location of the spill or release.
(c) Anticipated bypasses [40 CFR 122.41(m)(3)]	A report at least ten days before the date of the bypass, if possible. The report shall include an evaluation of the anticipated quality and effect of the bypass.
(d) Unanticipated bypasses [40 CFR 122.41(m)(3)]	Within 24 hours, an oral or electronic notification. Within 7 calendar days, a report that includes an evaluation of the quality and effect of the bypass.
(e) Noncompliance with the conditions of this permit that may endanger health or the environment[40 CFR 122.41(I)(7)]	 Within 24 hours, an oral or electronic notification. Within 7 calendar days, a report that contains a description of the noncompliance, and its causes; the period of noncompliance, including exact dates and times, and if the noncompliance has not been corrected, the anticipated time noncompliance is expected to continue; and steps taken or planned to reduce, eliminate, and prevent reoccurrence of the noncompliance. [40 CFR 122.41(I)(6). Division staff may waive the requirement for a written report on a case-by-case basis.



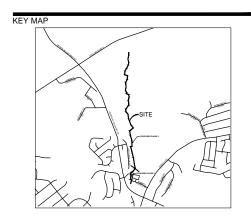NCG01 SELF-INSPECTION, RECORDKEEPING AND REPORTING

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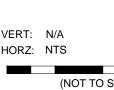
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